



SECOND FLOOR (8 DWELLING UNITS)


GROSS AREA = 9,060 s.f. OCCUPANCY LOAD = 40

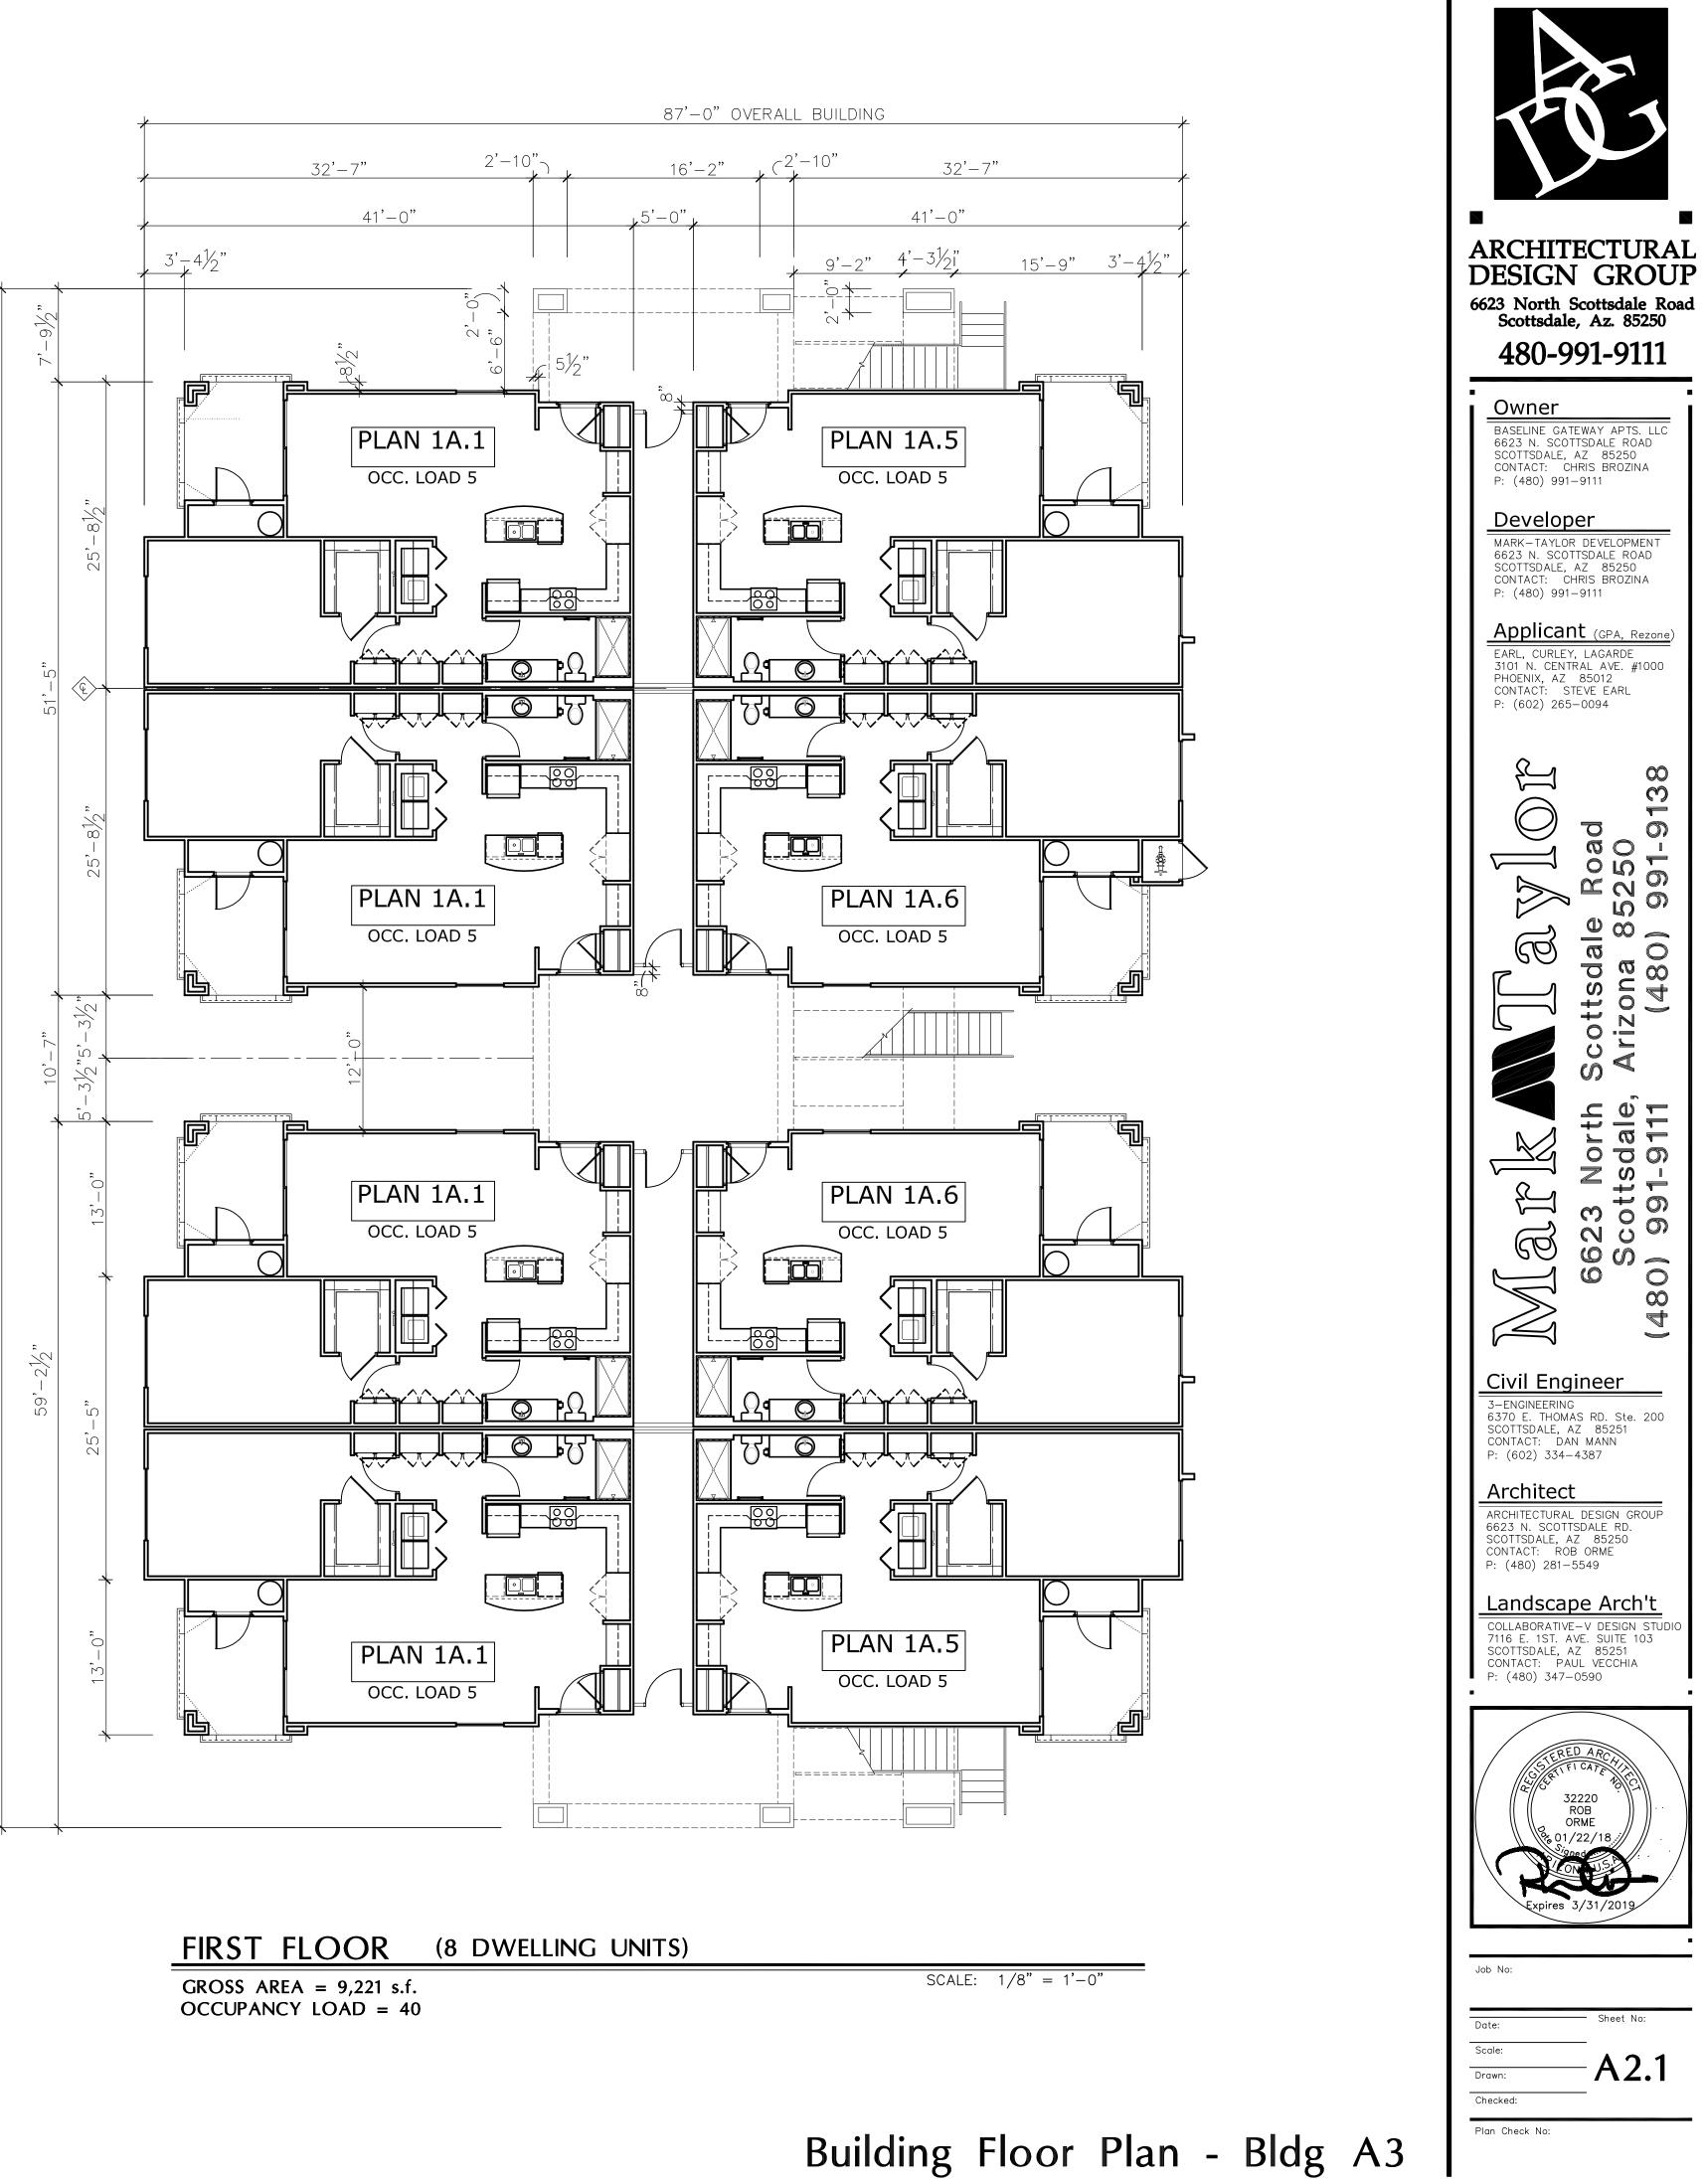



SCALE: 1/8" = 1'-0"

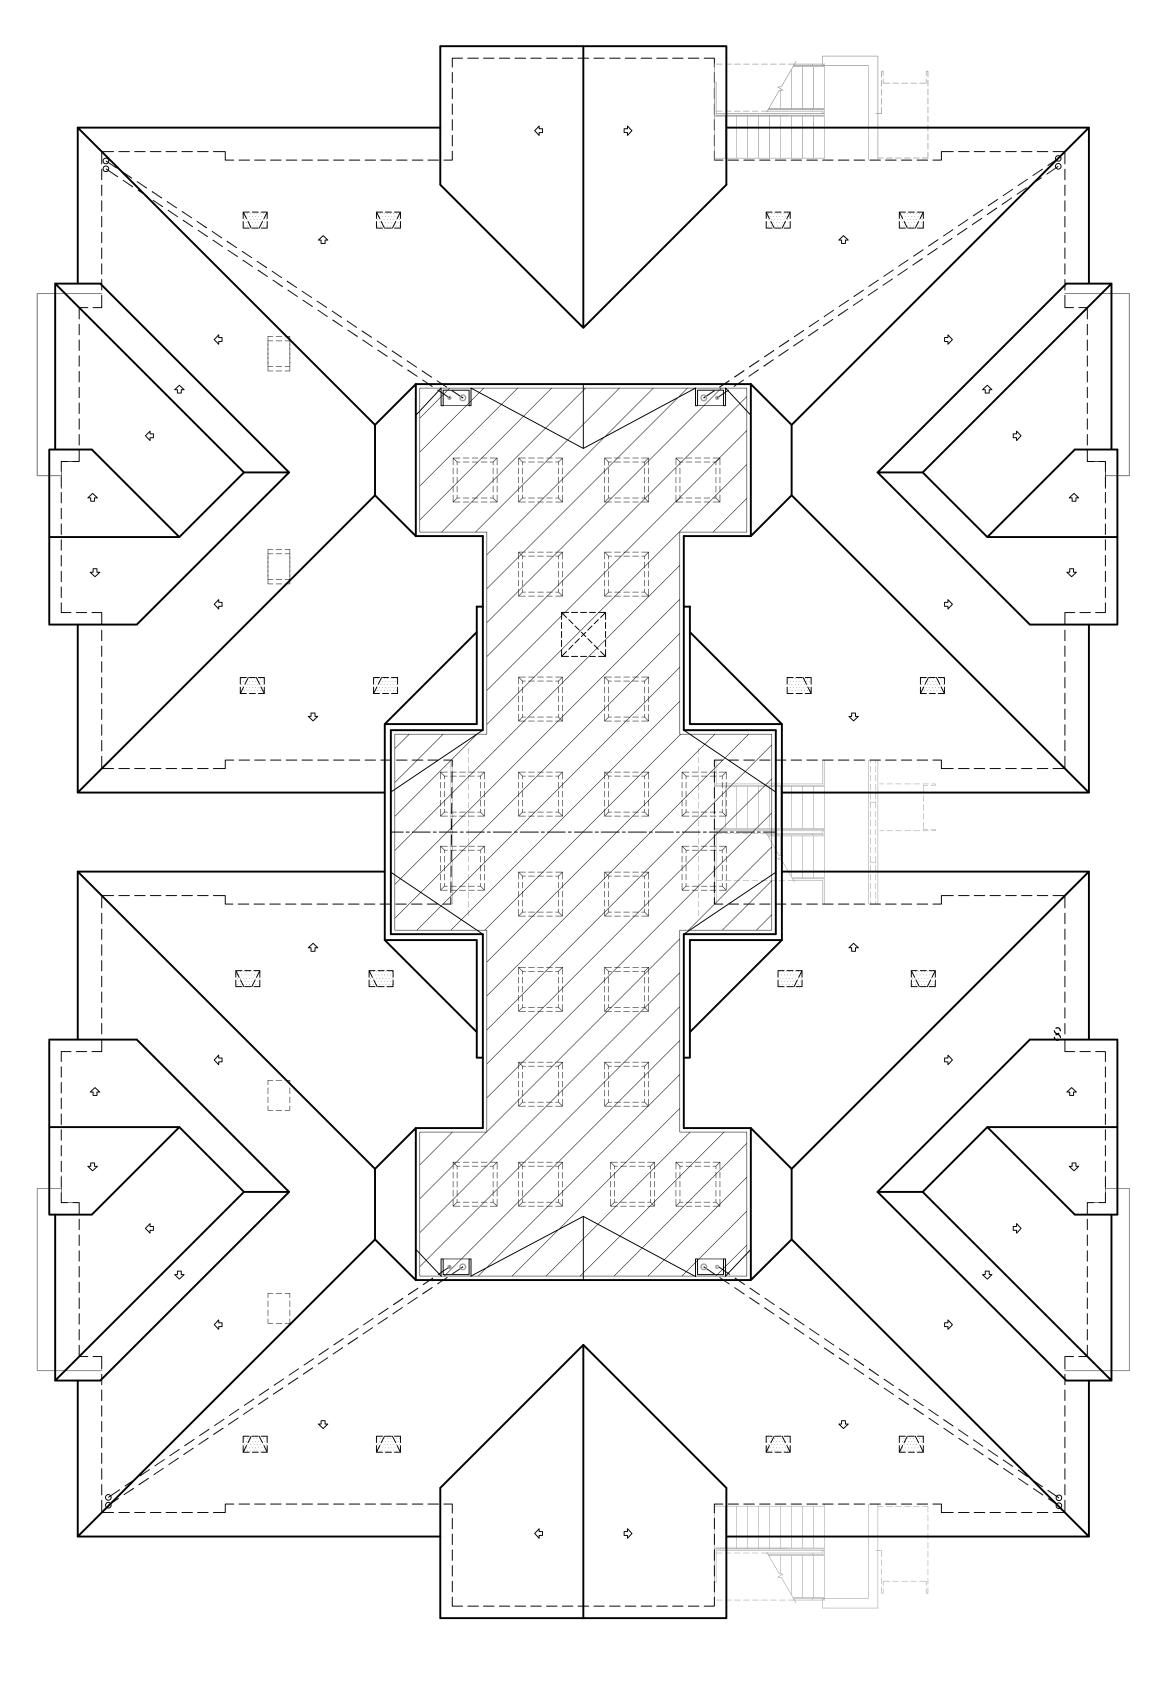




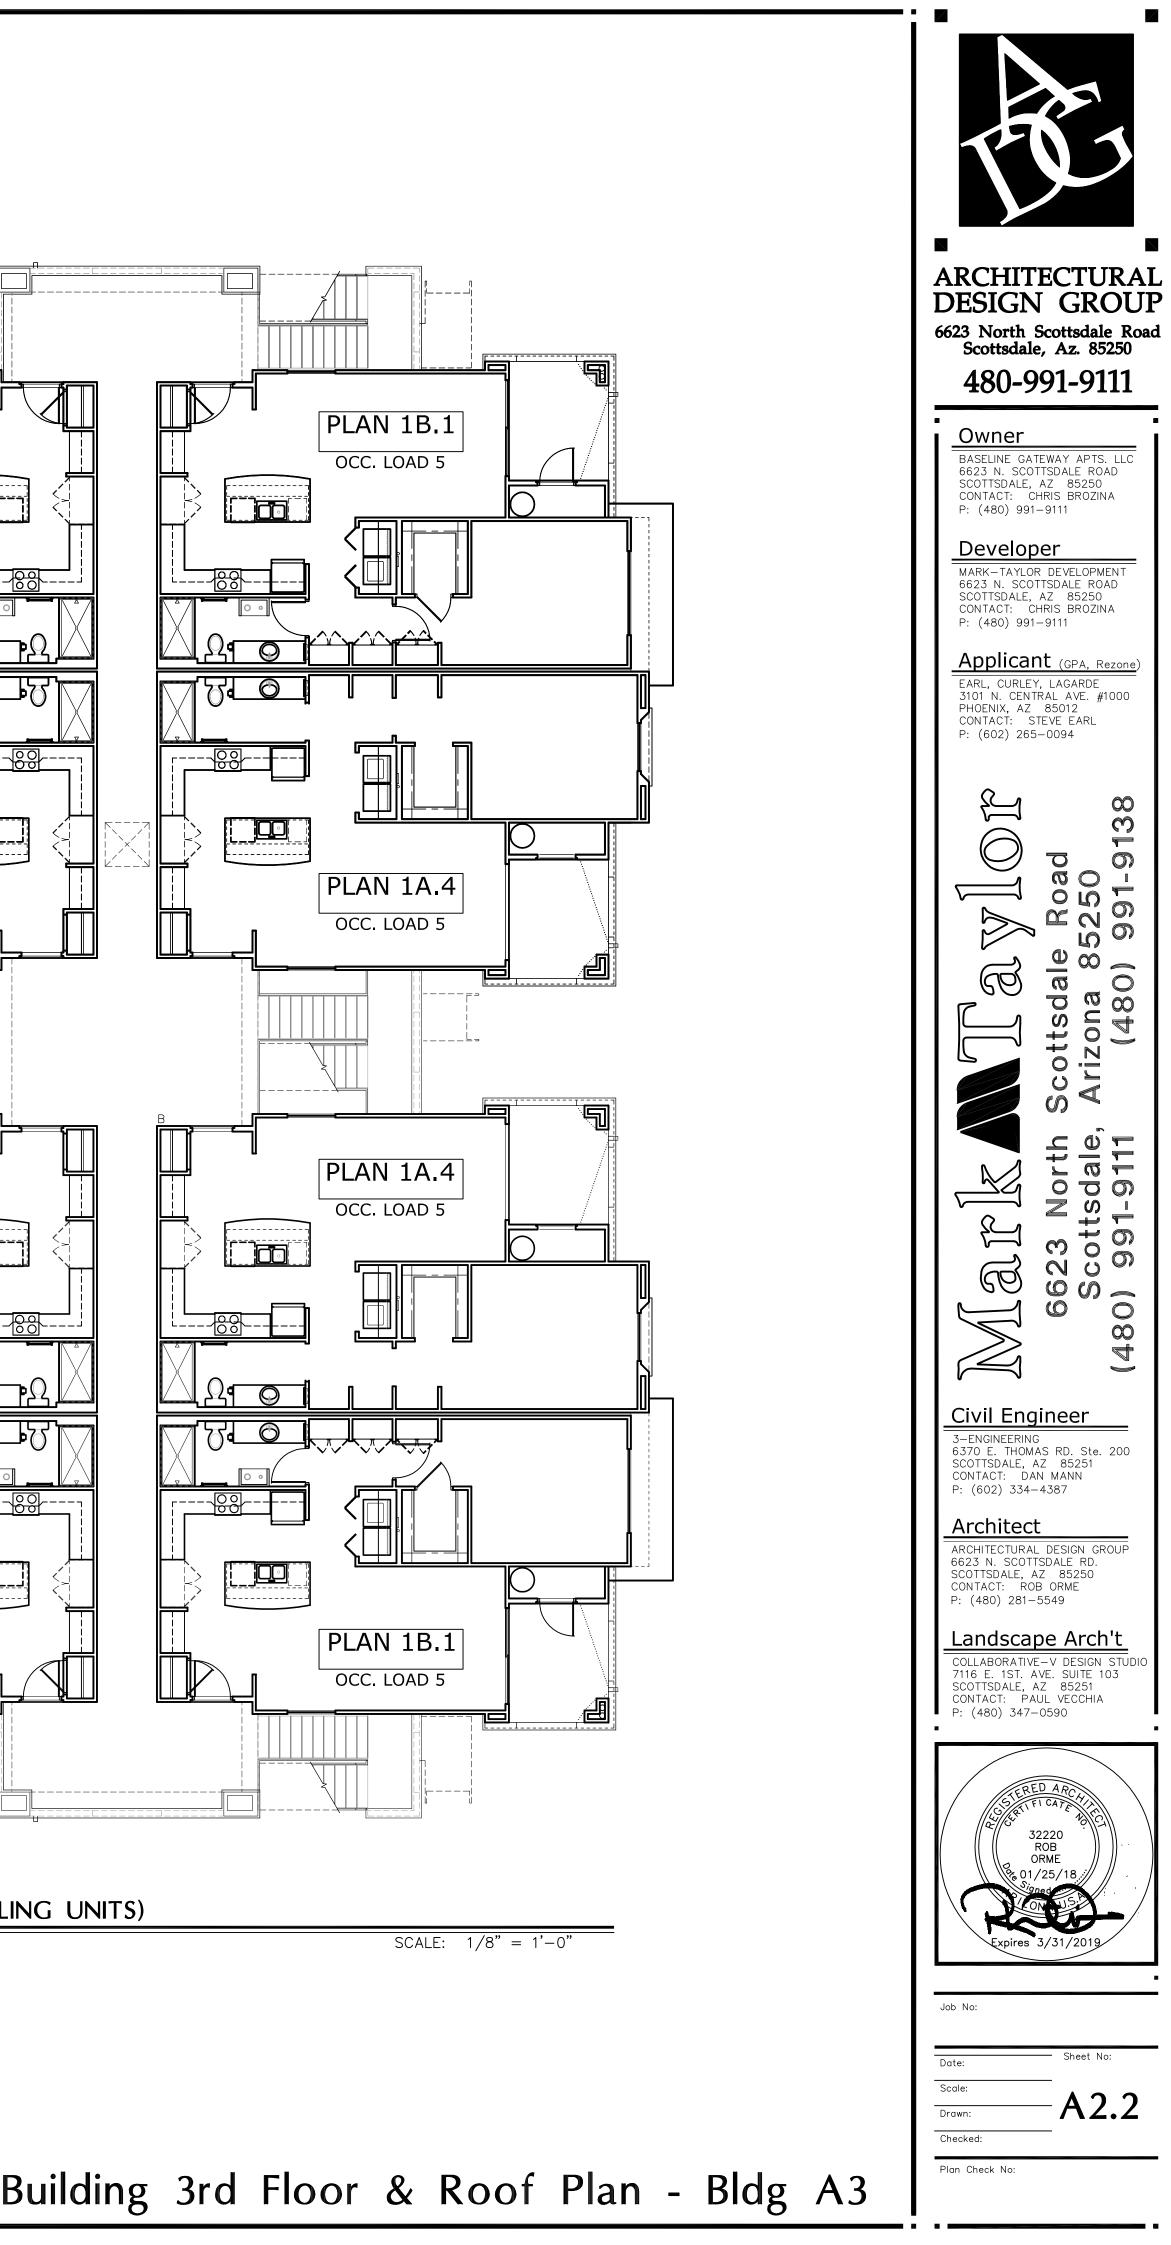


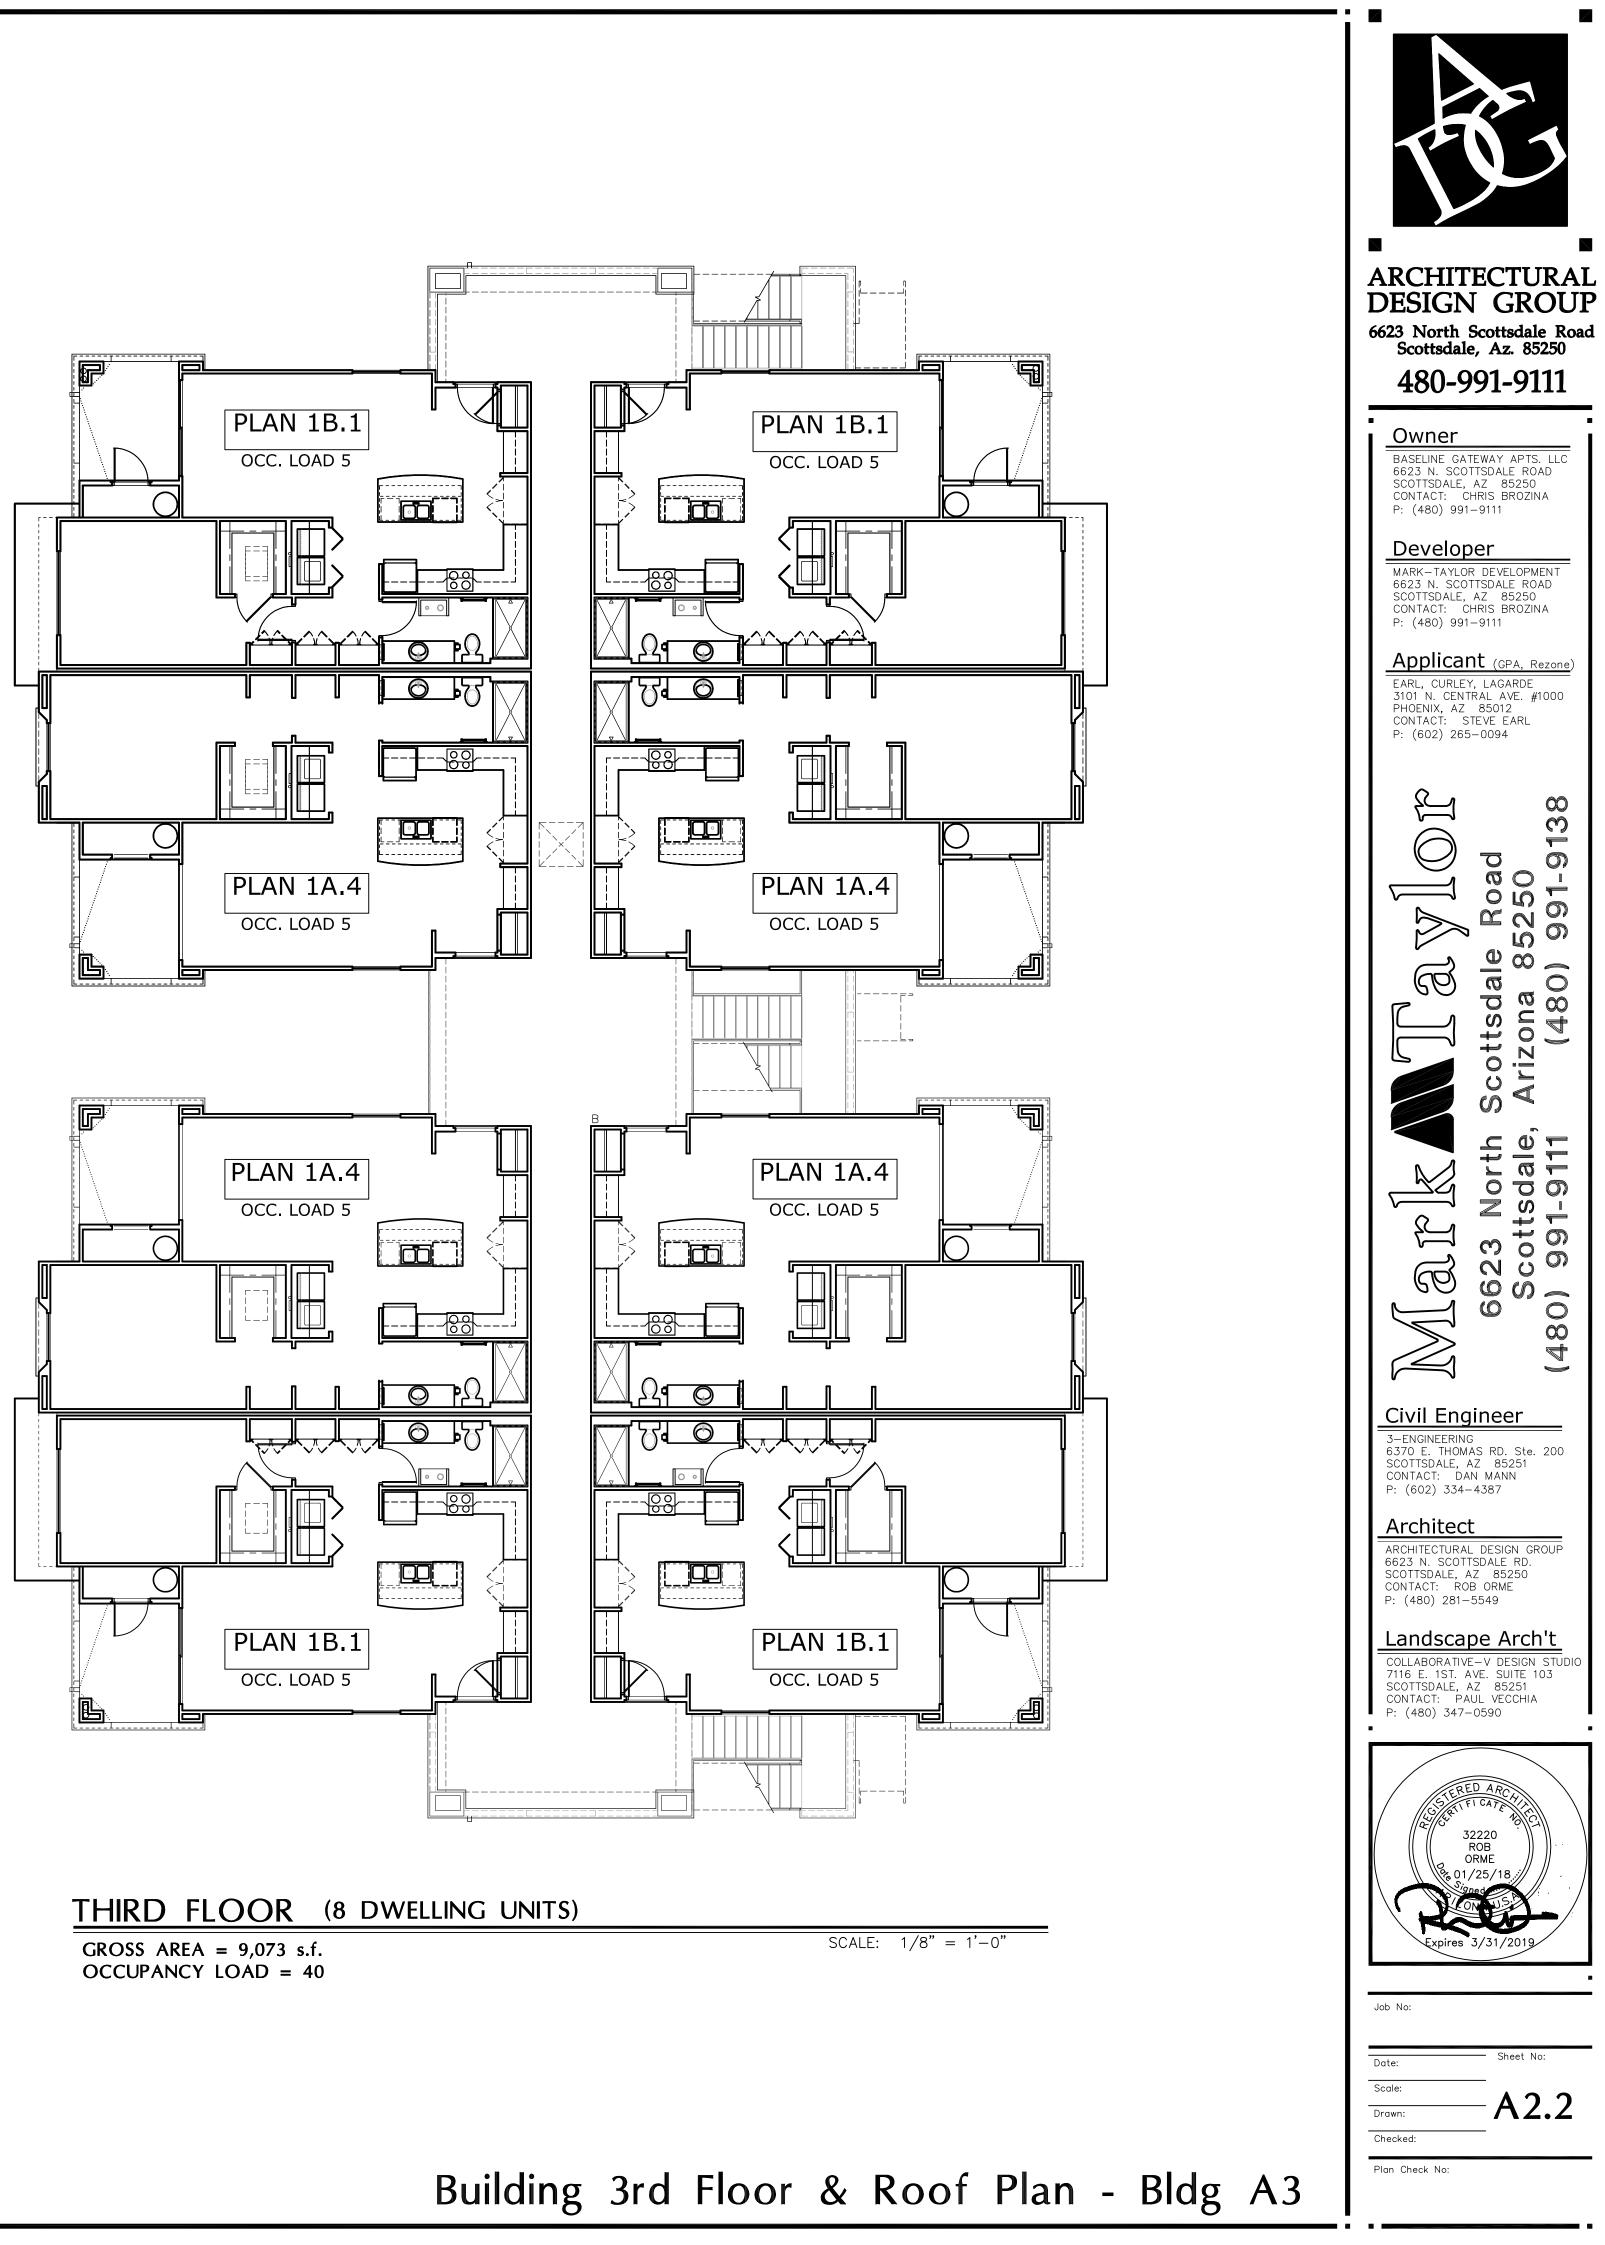


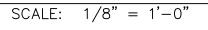

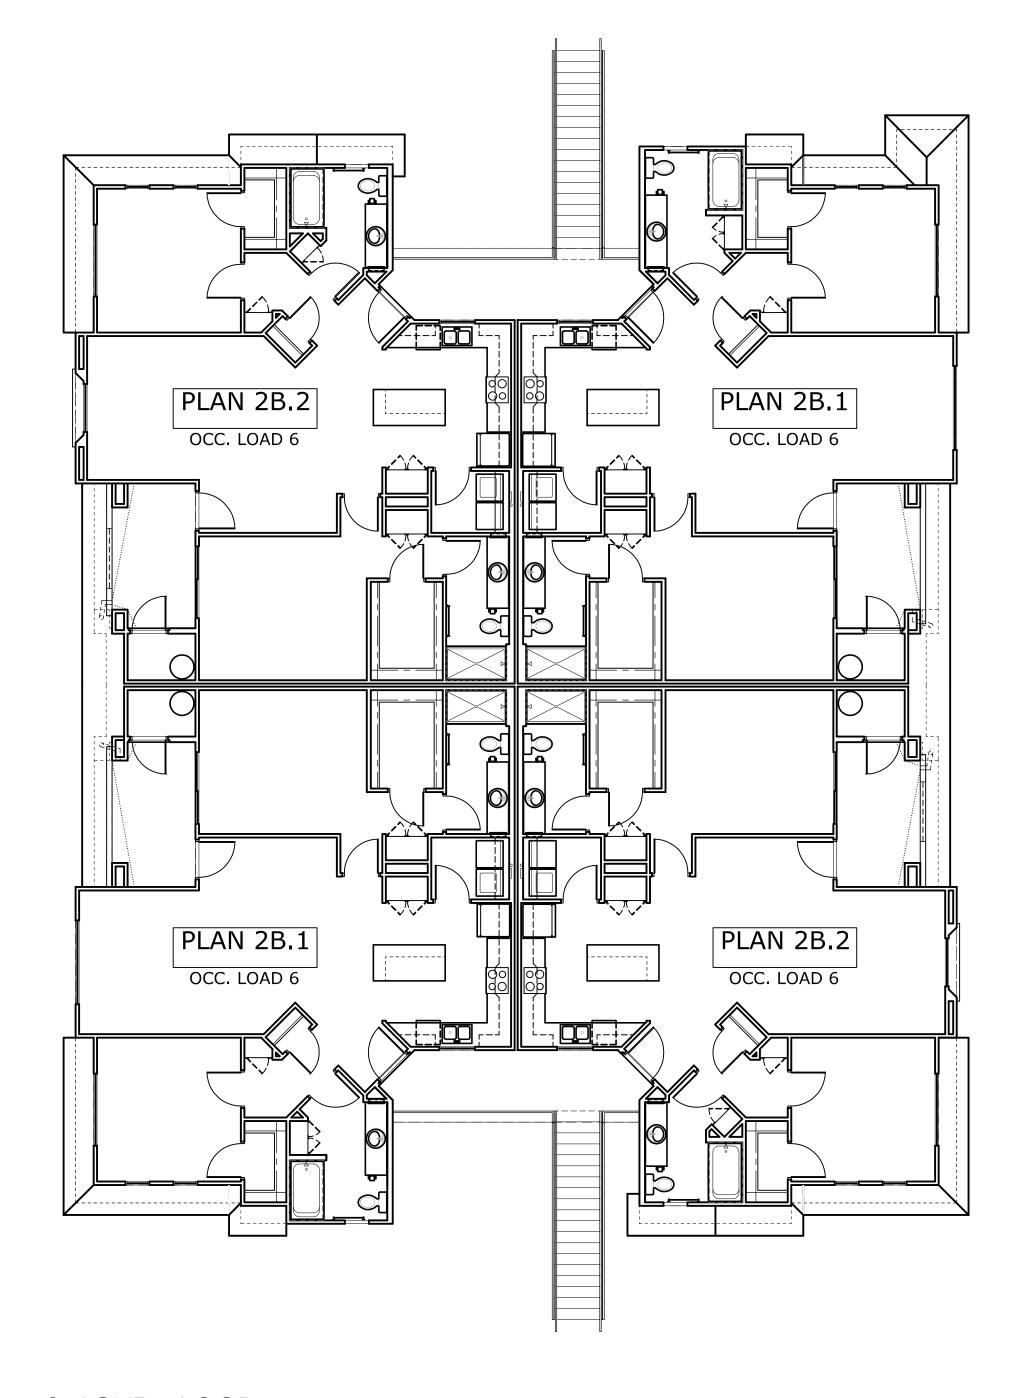


SECOND FLOOR (4 DWELLING UNITS) GROSS AREA = 5,734 s.f. OCCUPANCY LOAD = 24

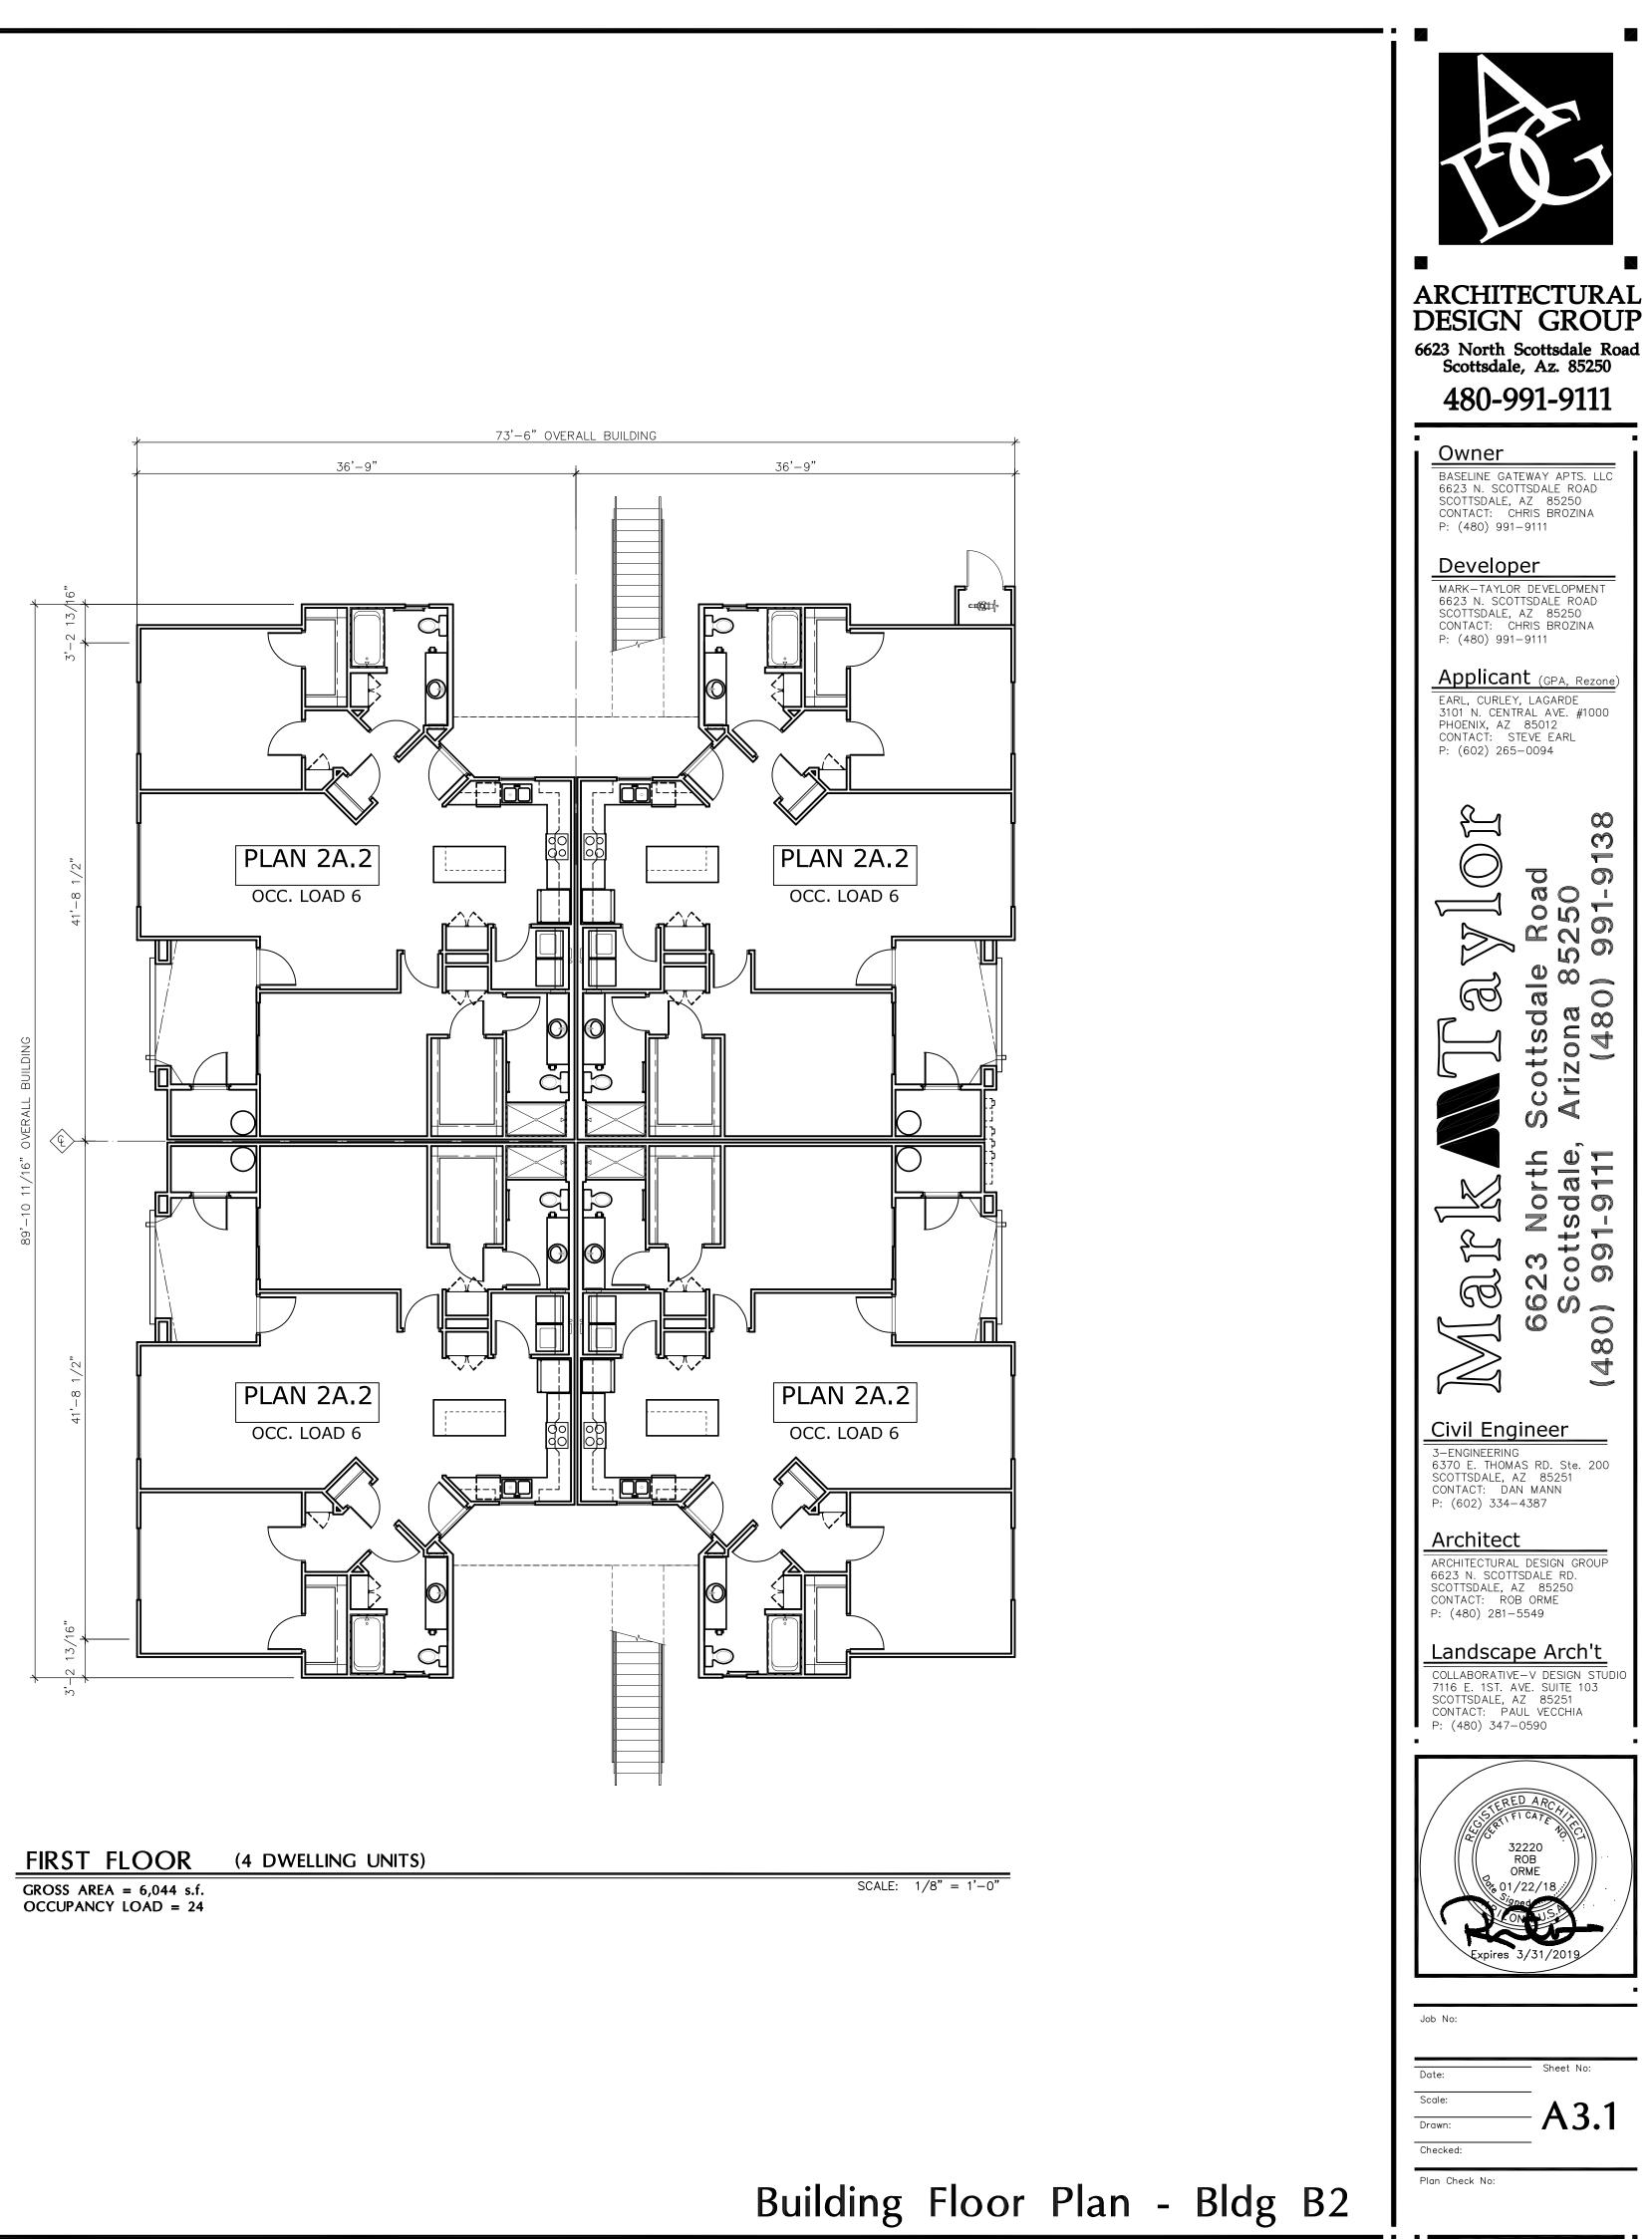


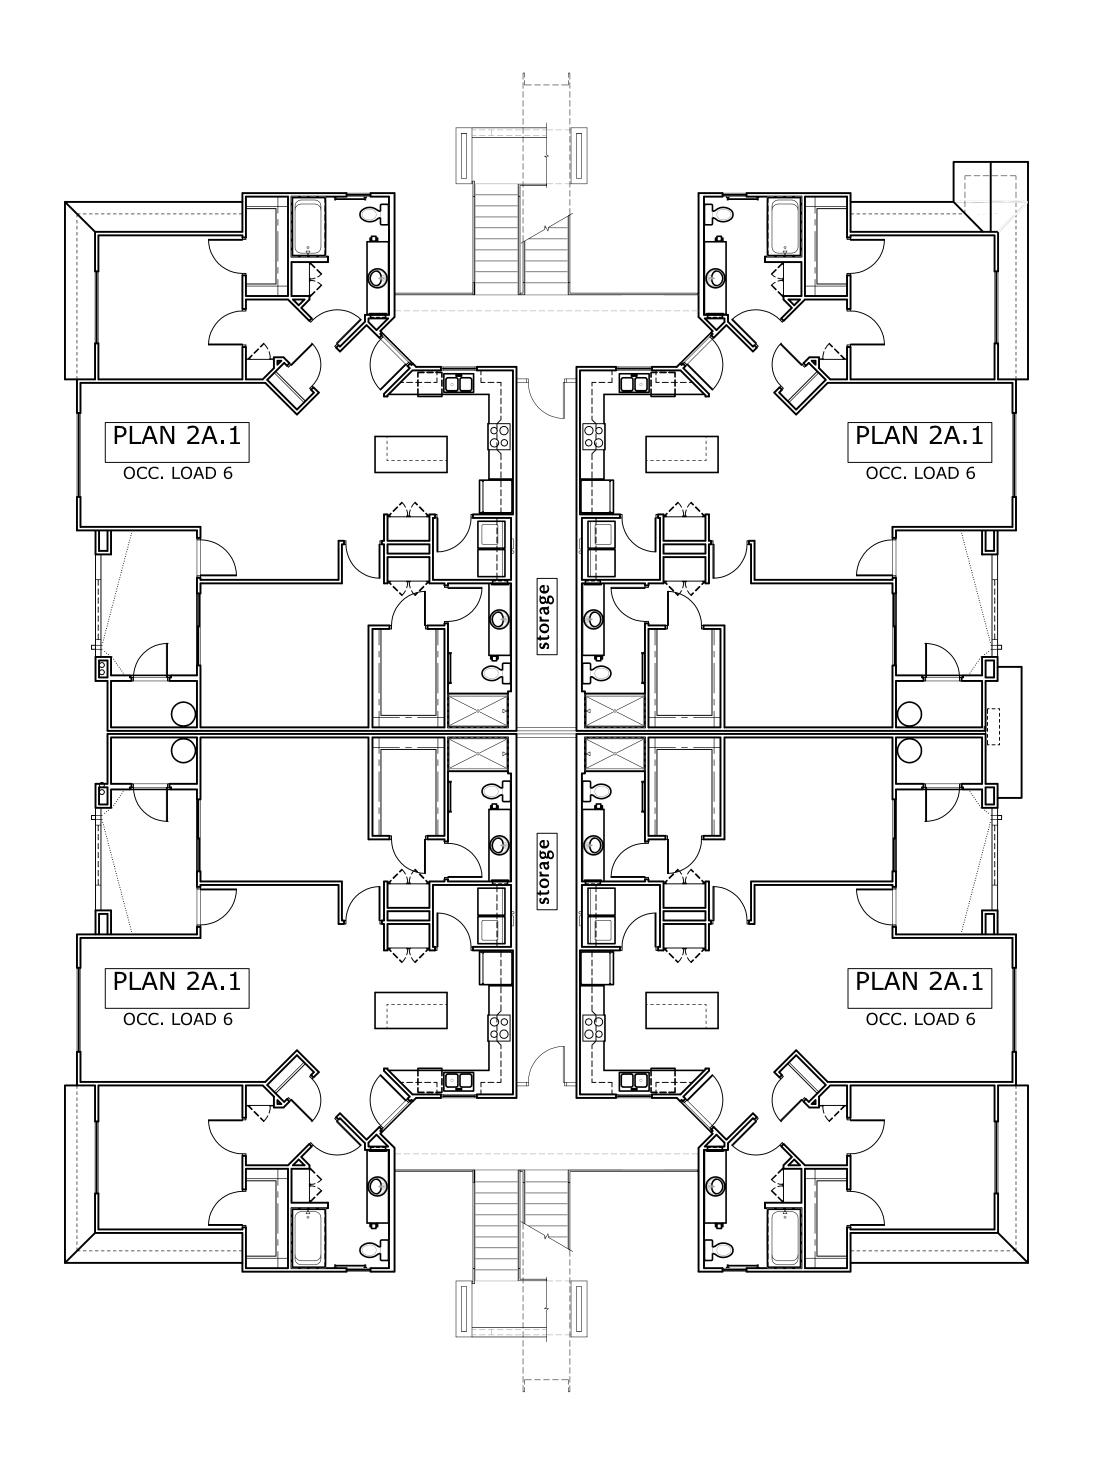



SECOND FLOOR (4 DWELLING UNITS)

GROSS AREA = 6,230 s.f. OCCUPANCY LOAD = 24

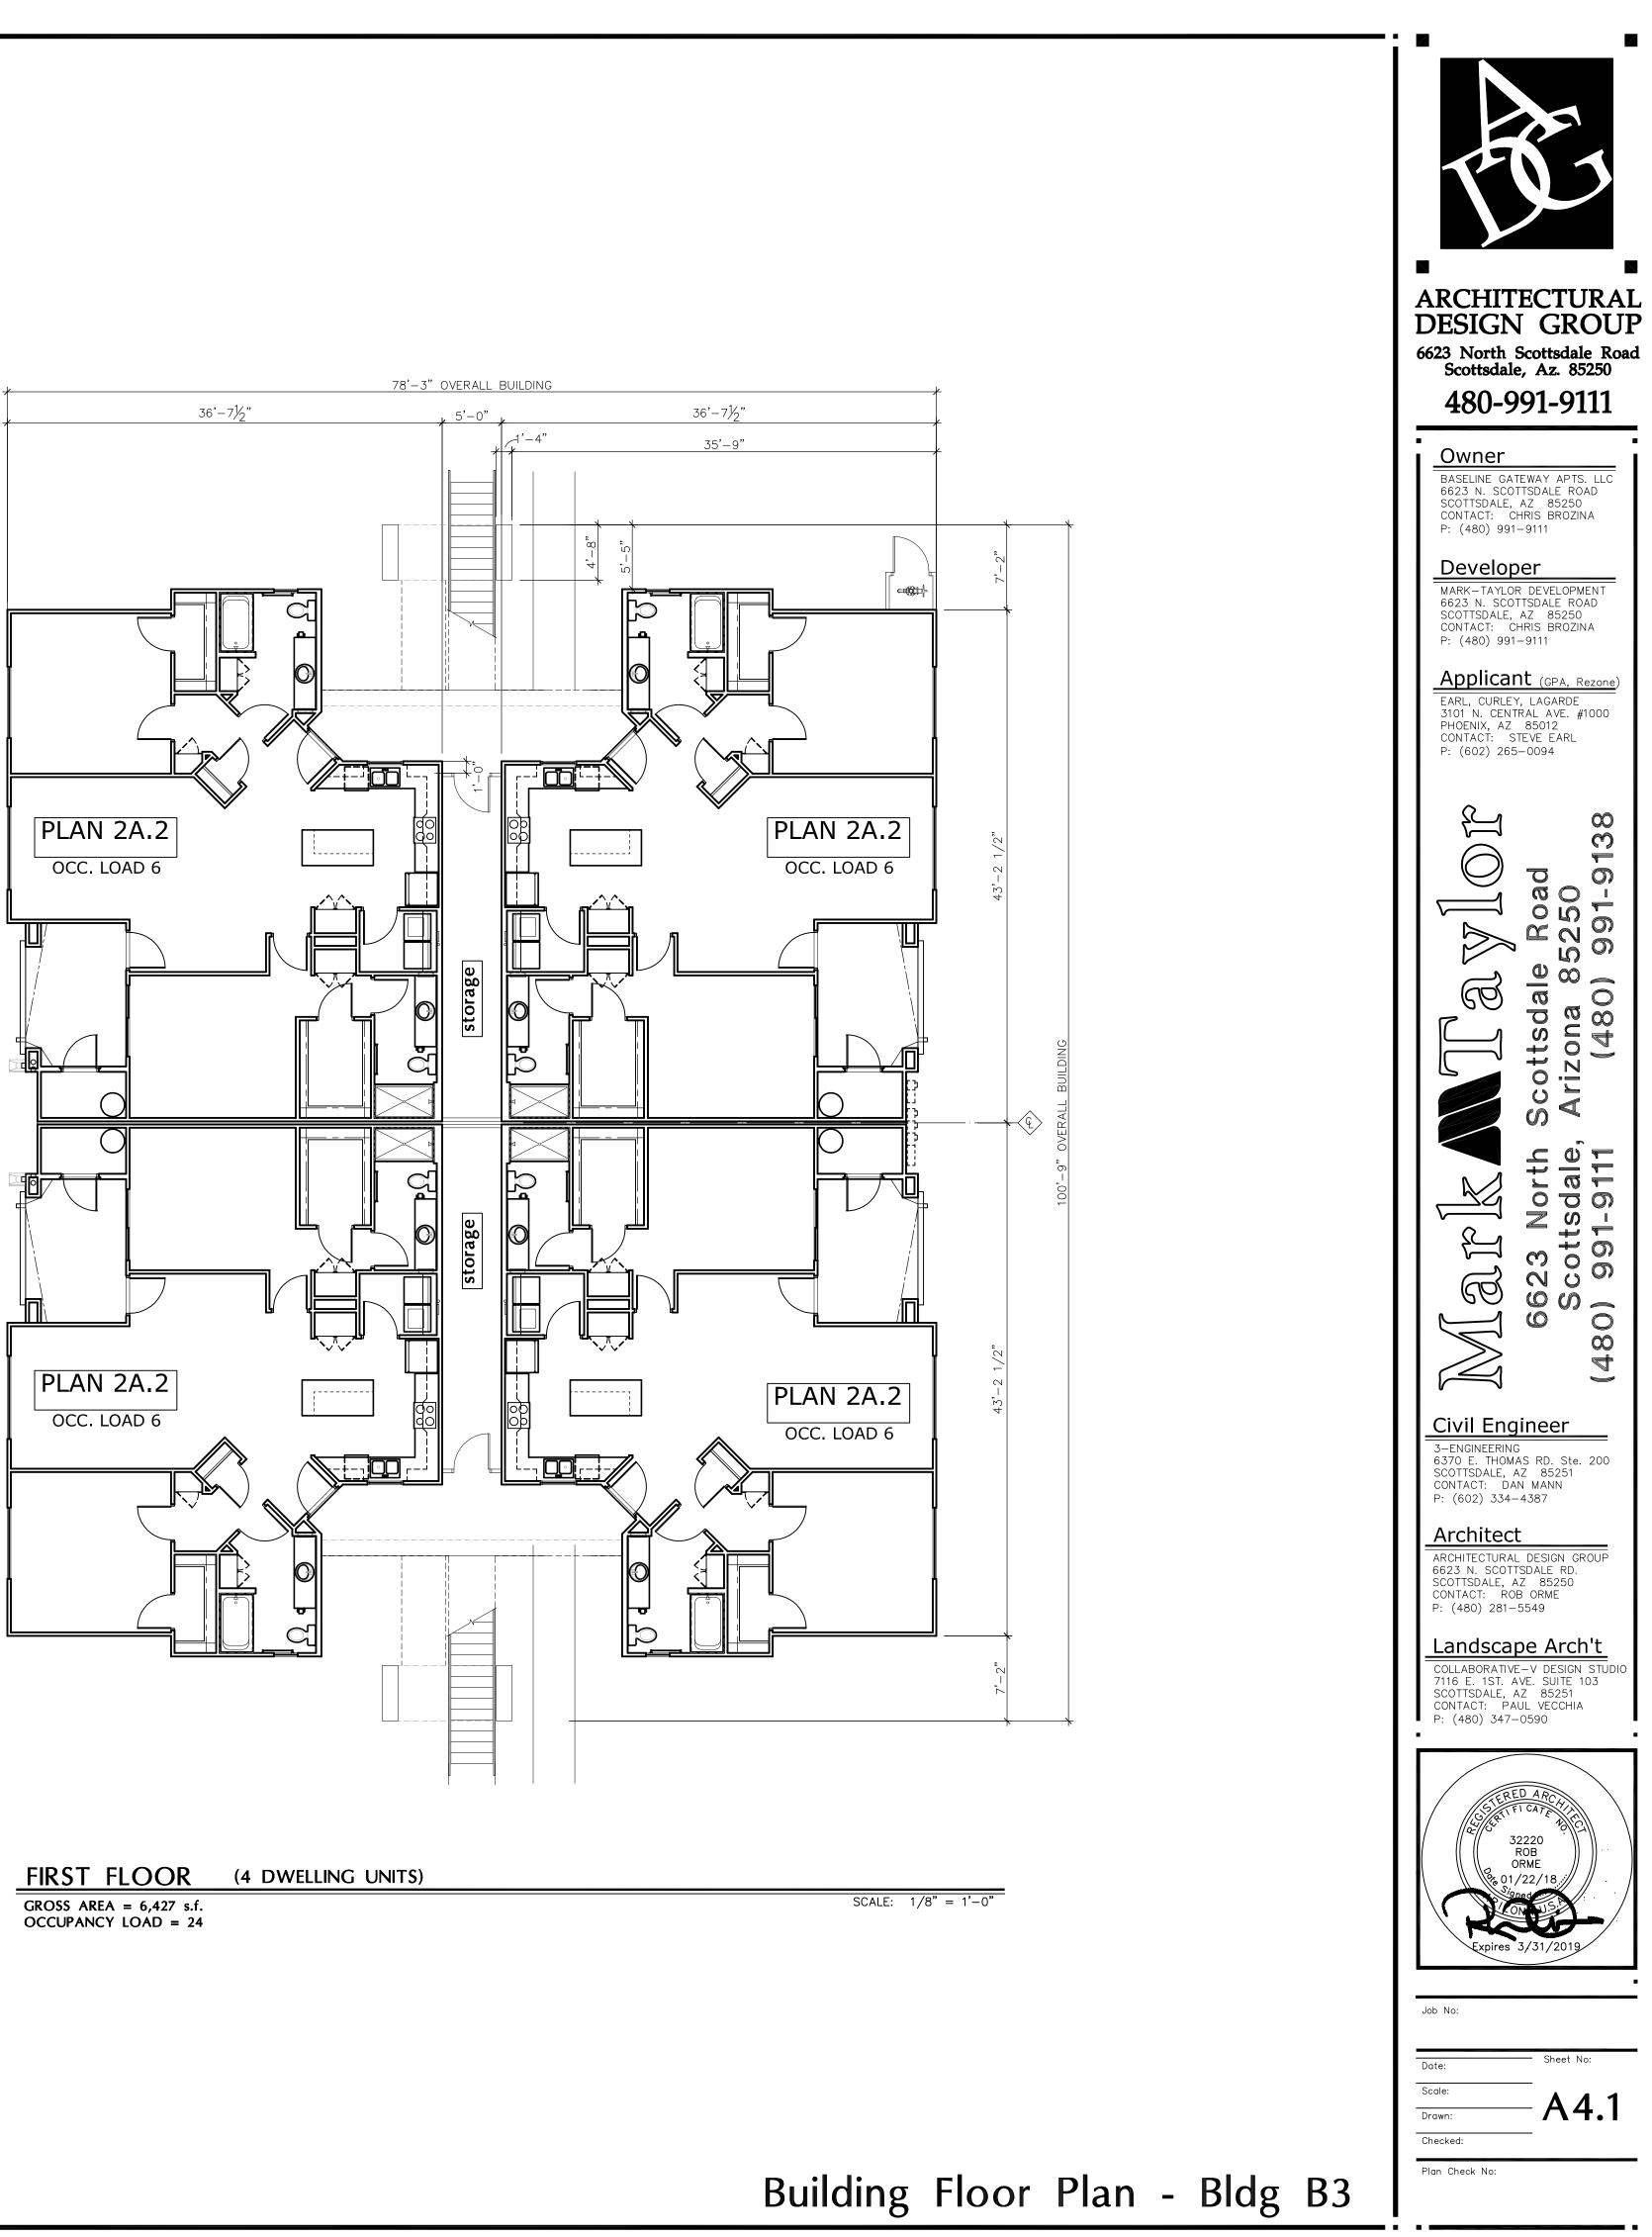

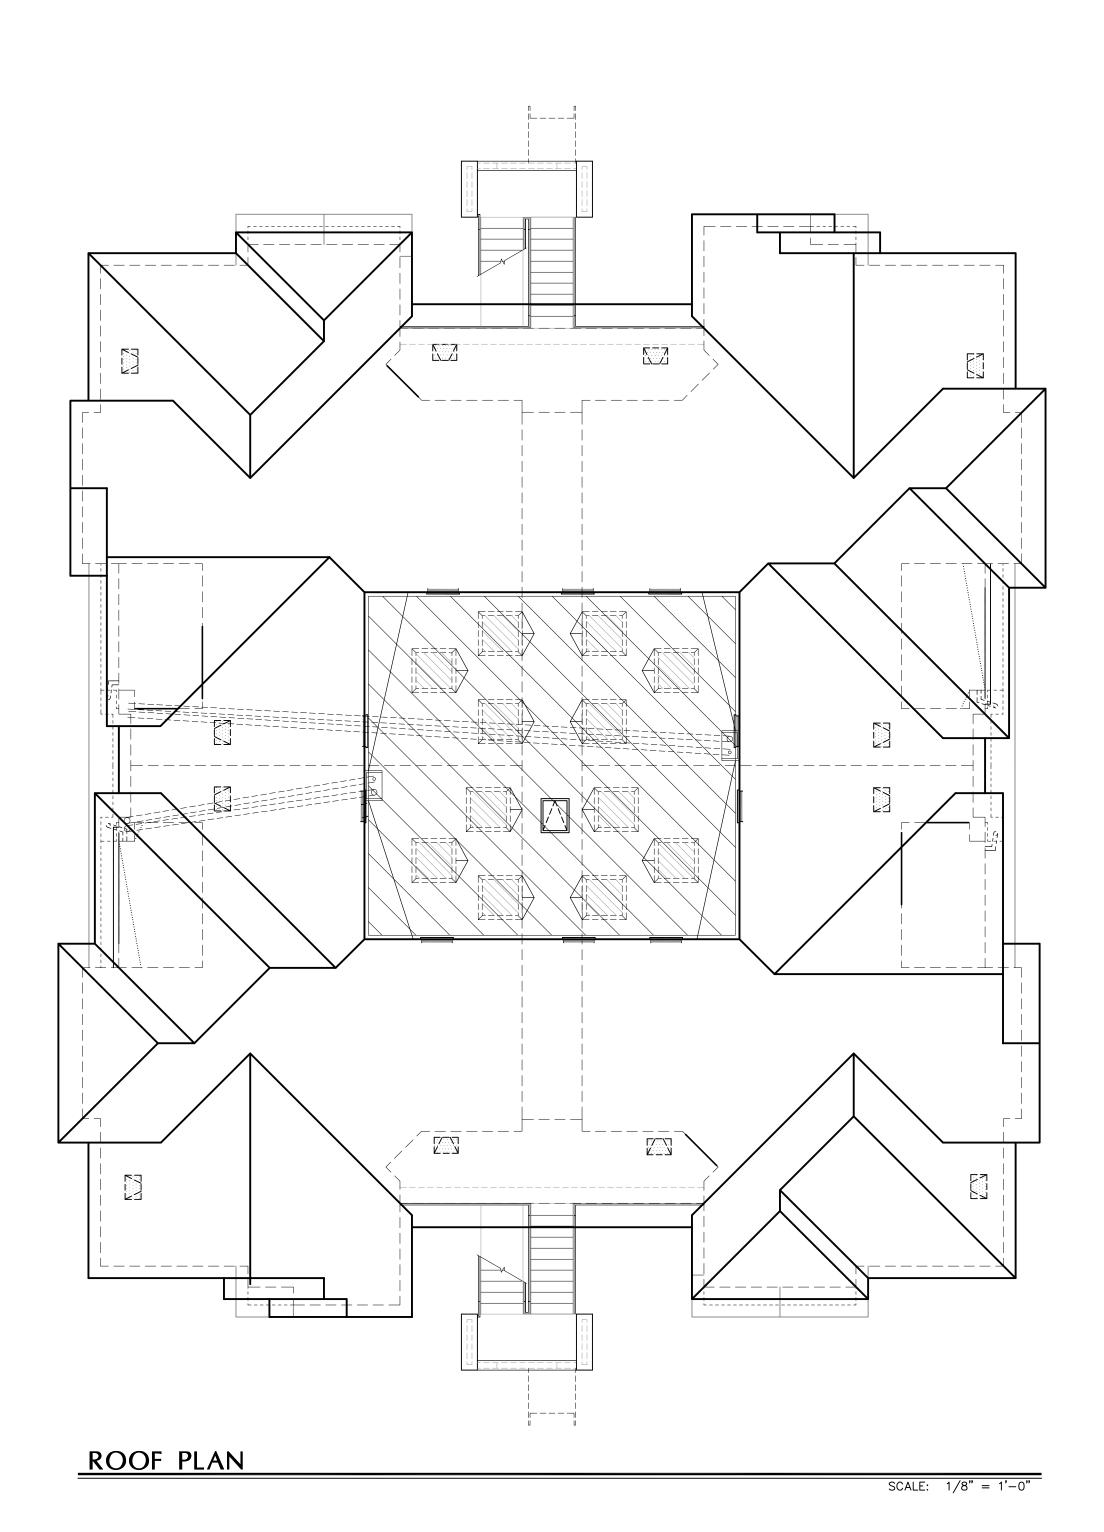


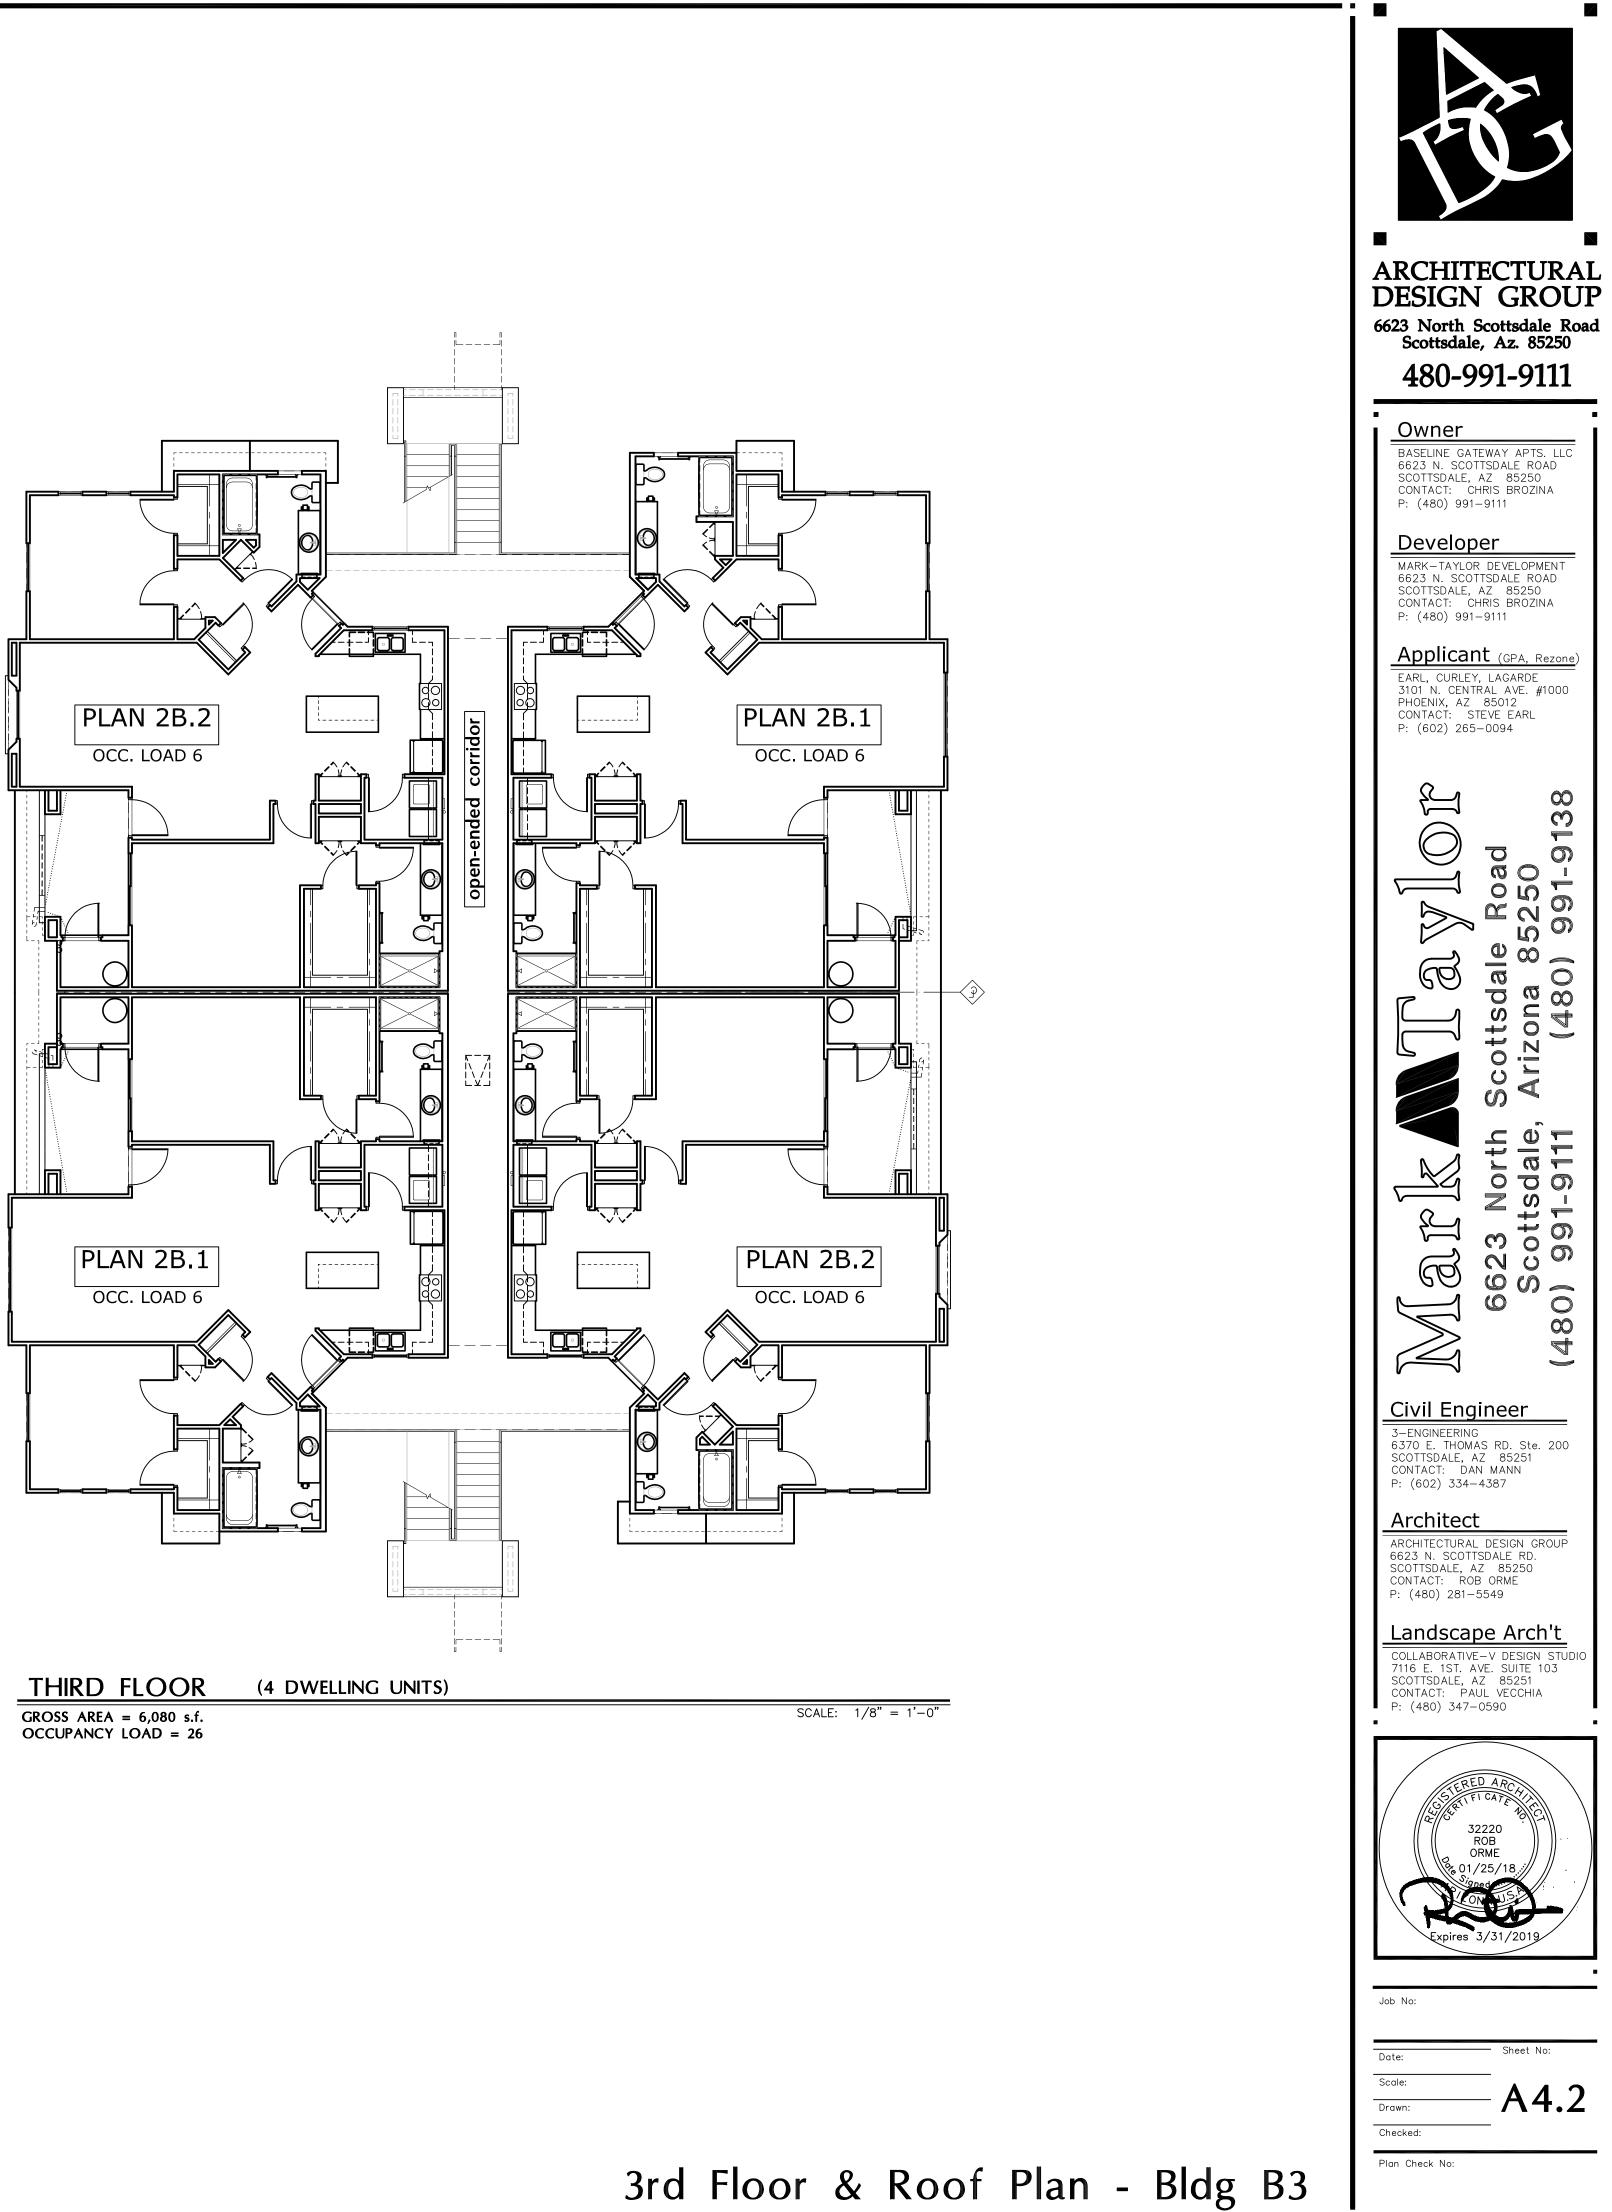


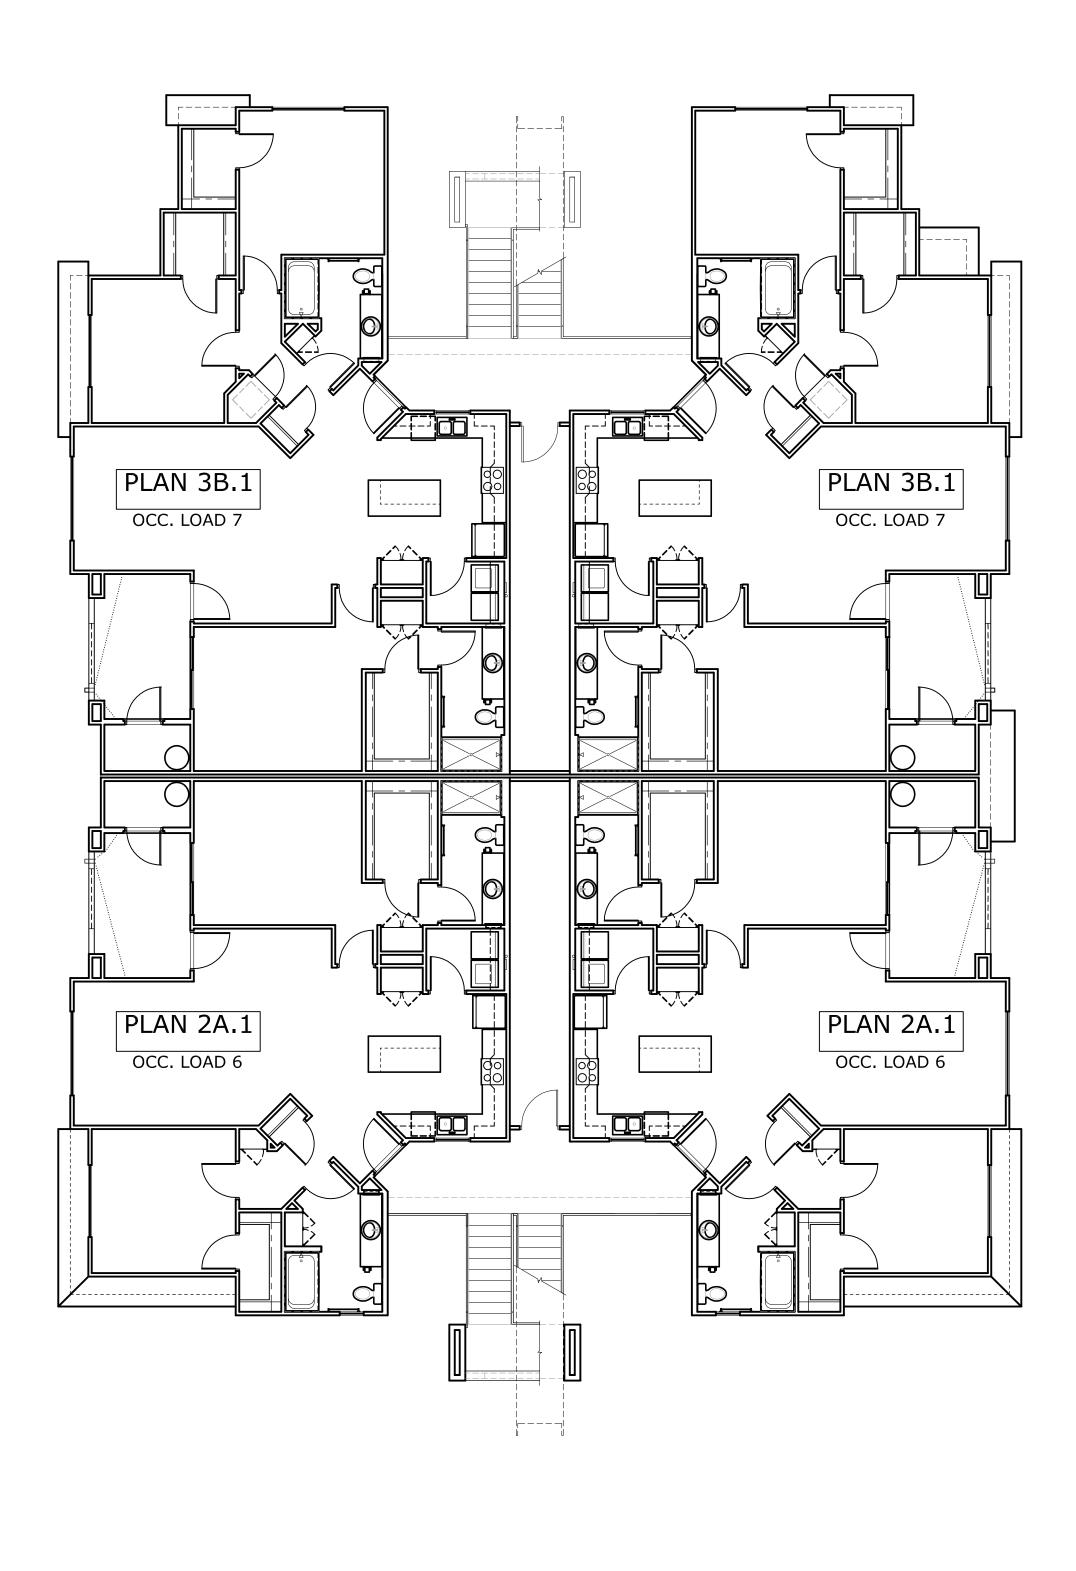


## SECOND FLOOR (4 DWELLING UNITS)

GROSS AREA = 6641 s.f.OCCUPANCY LOAD = 26

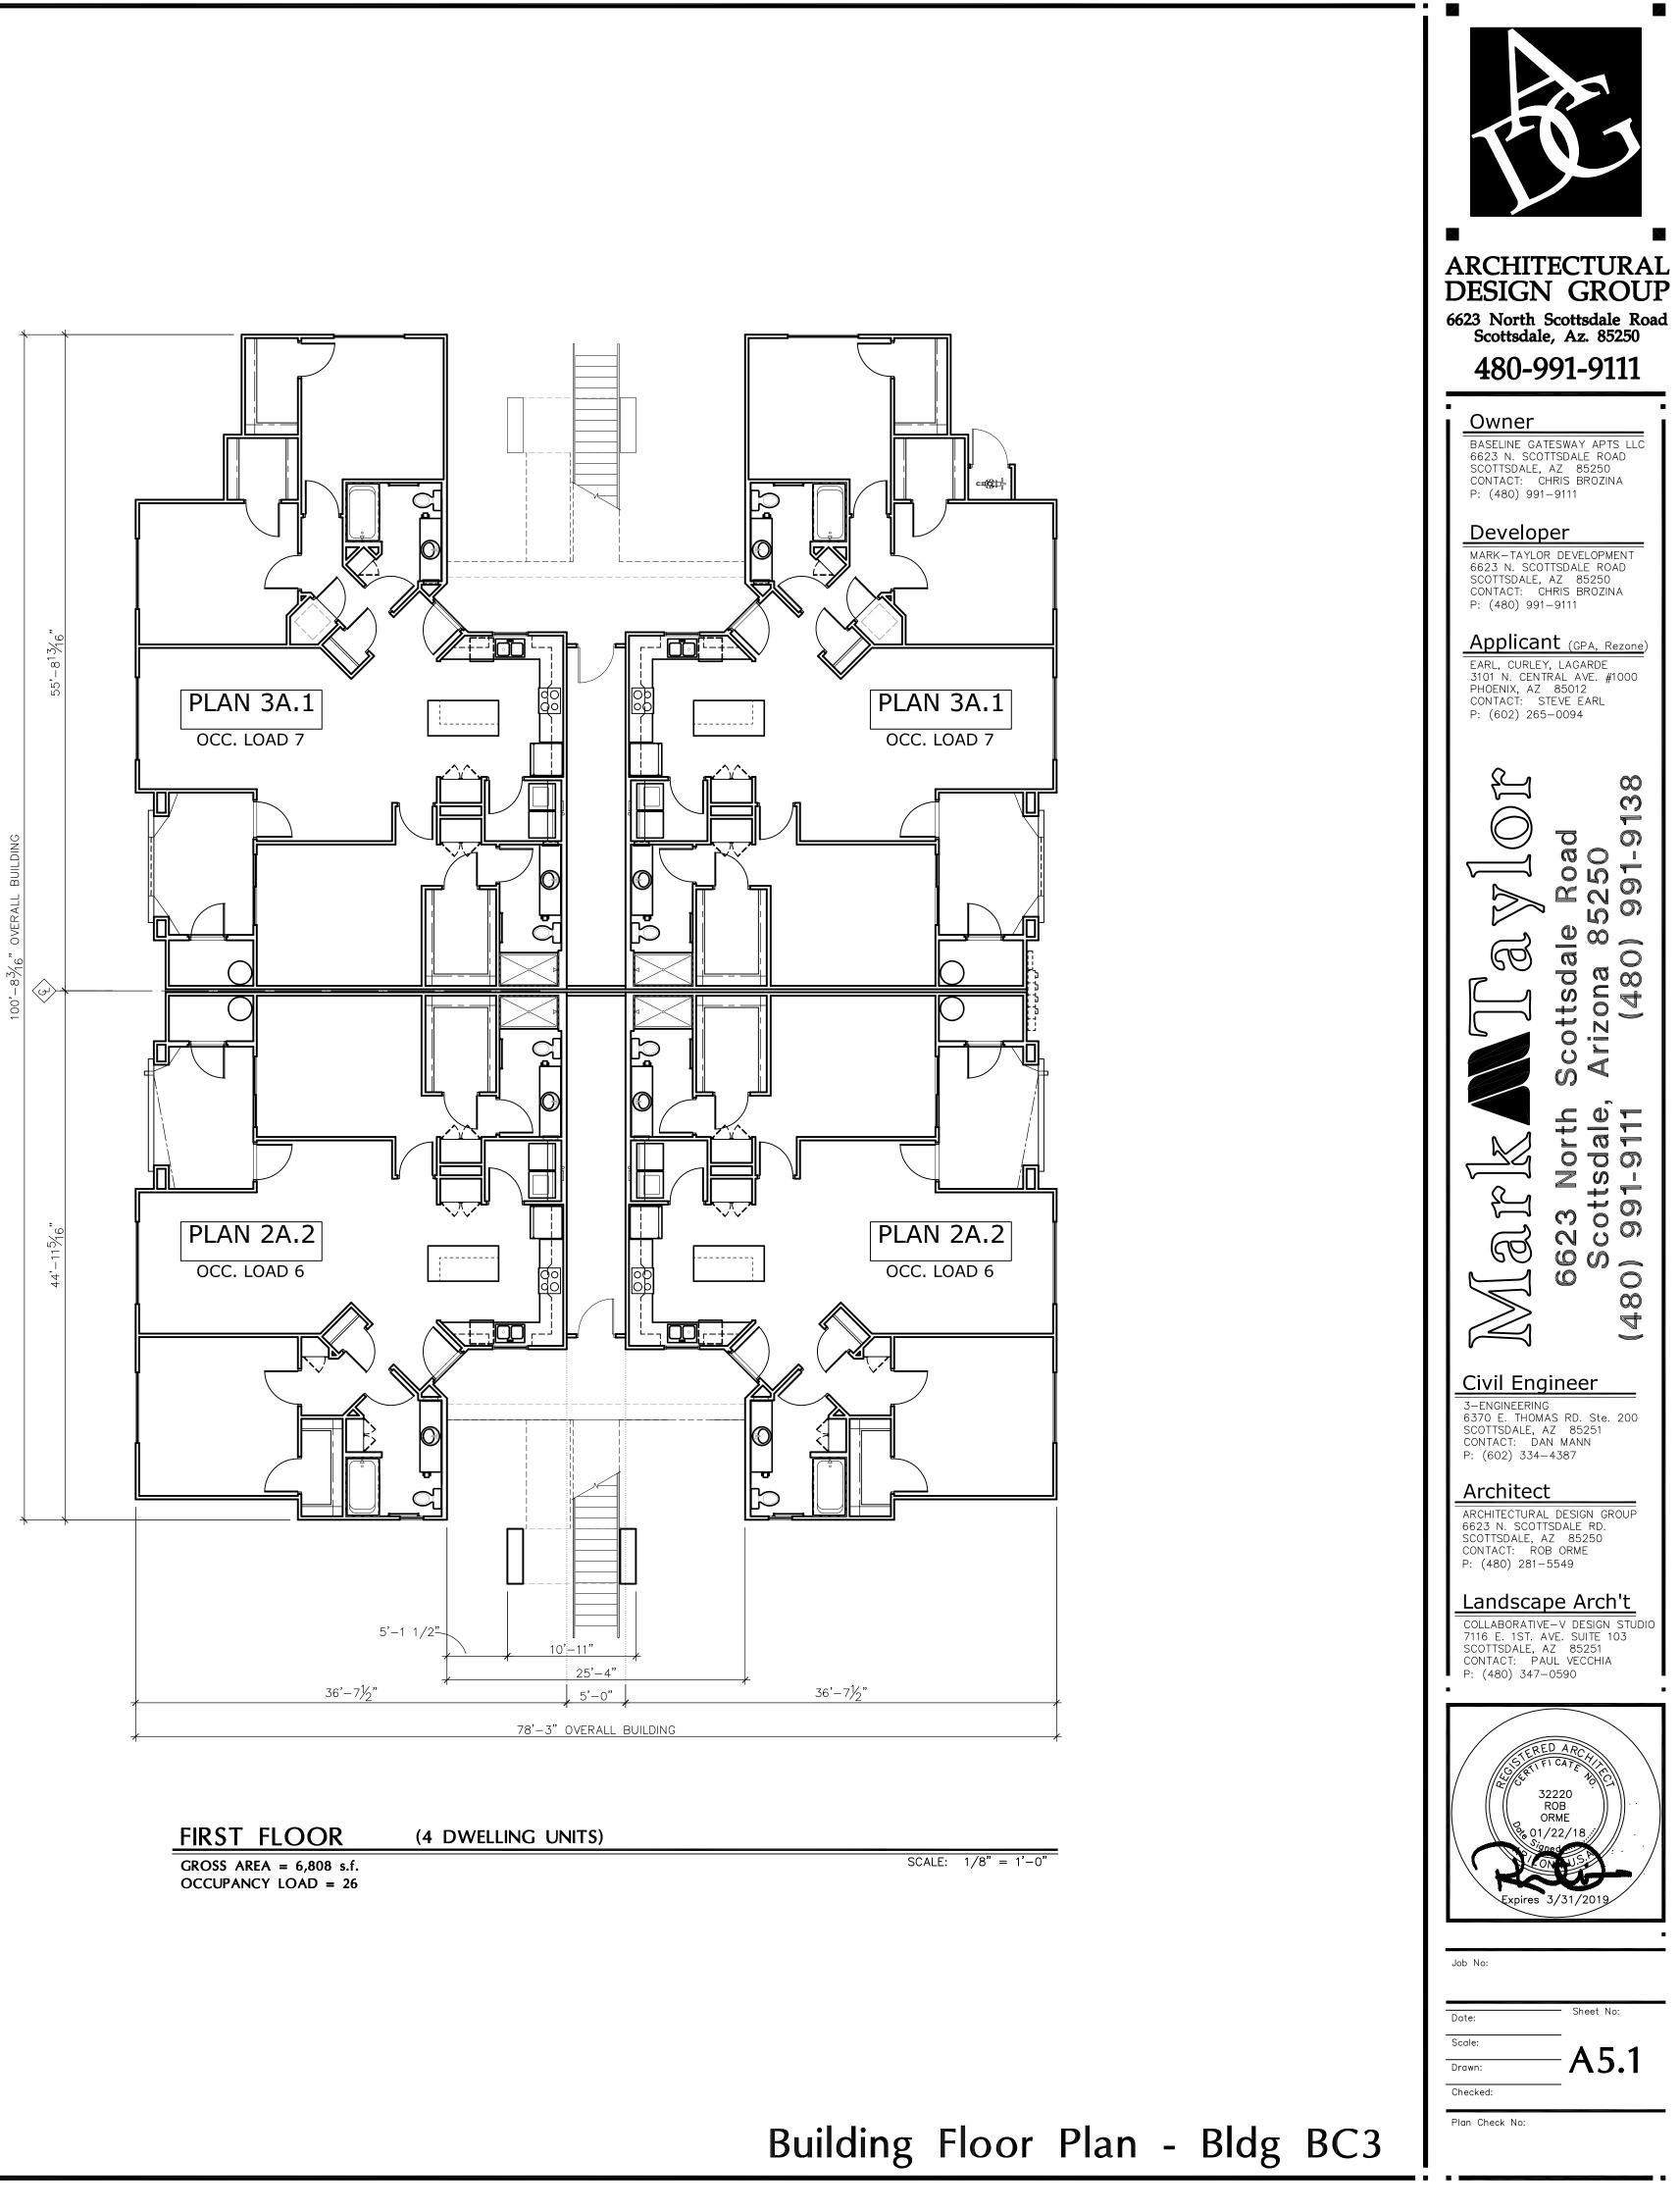


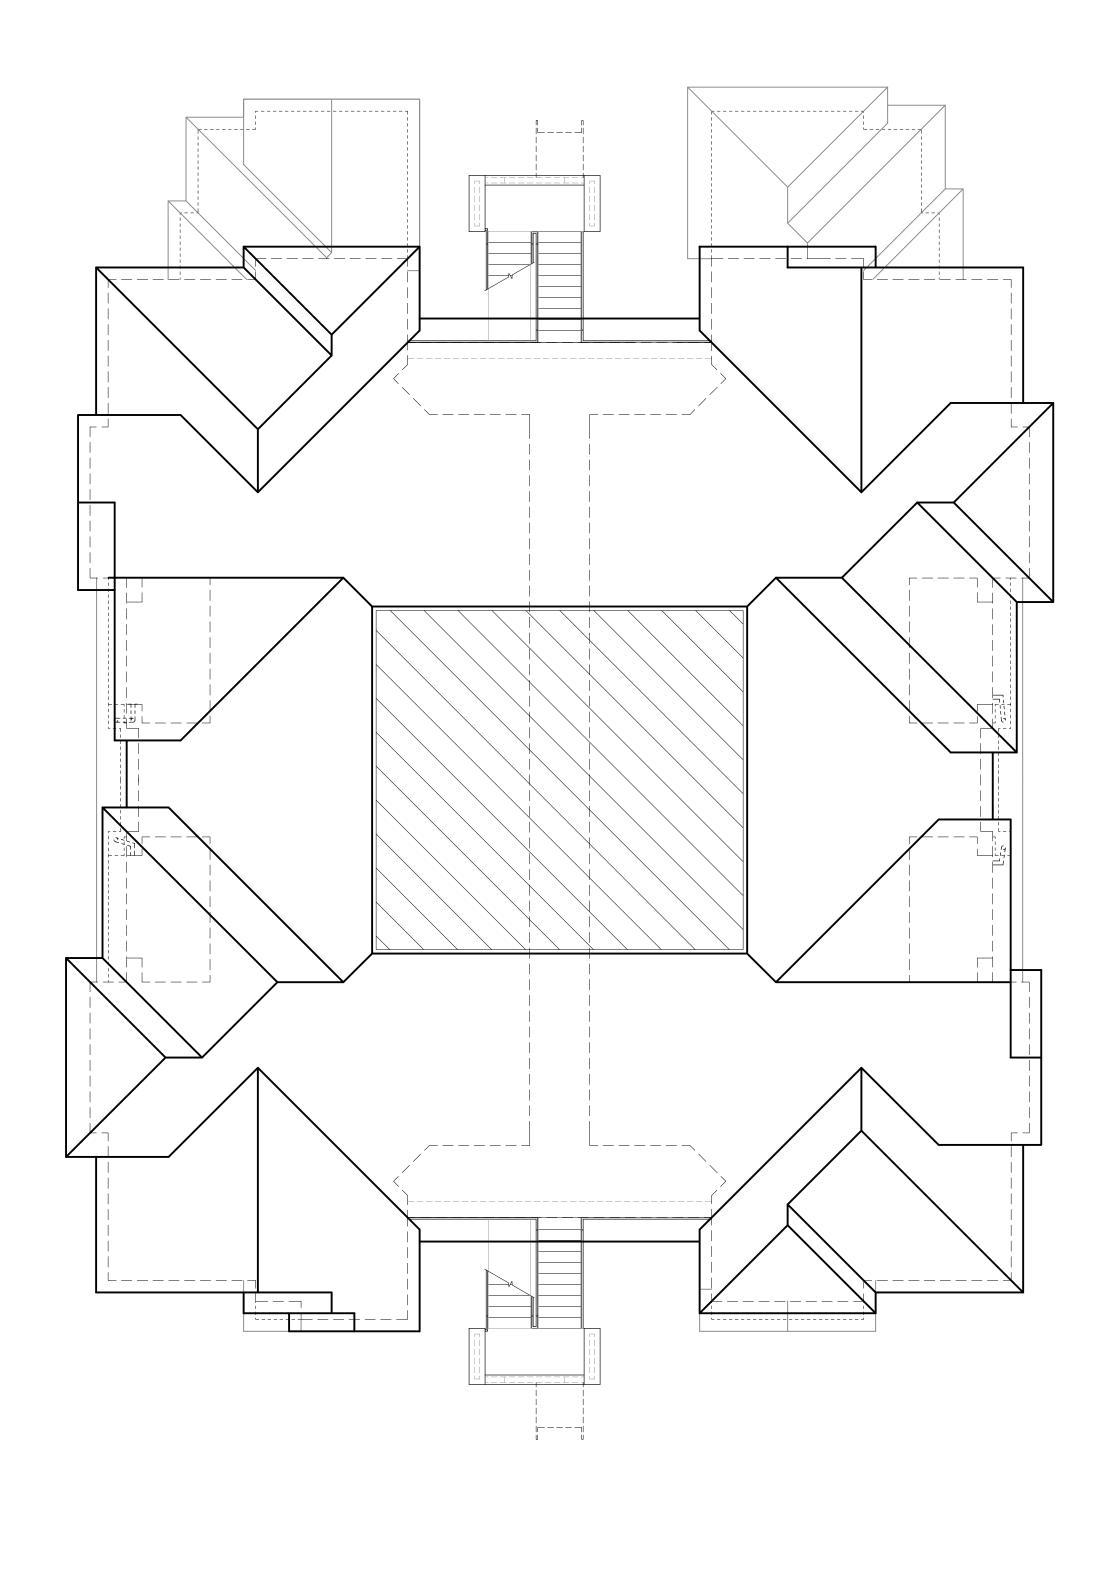



ROOF PLAN

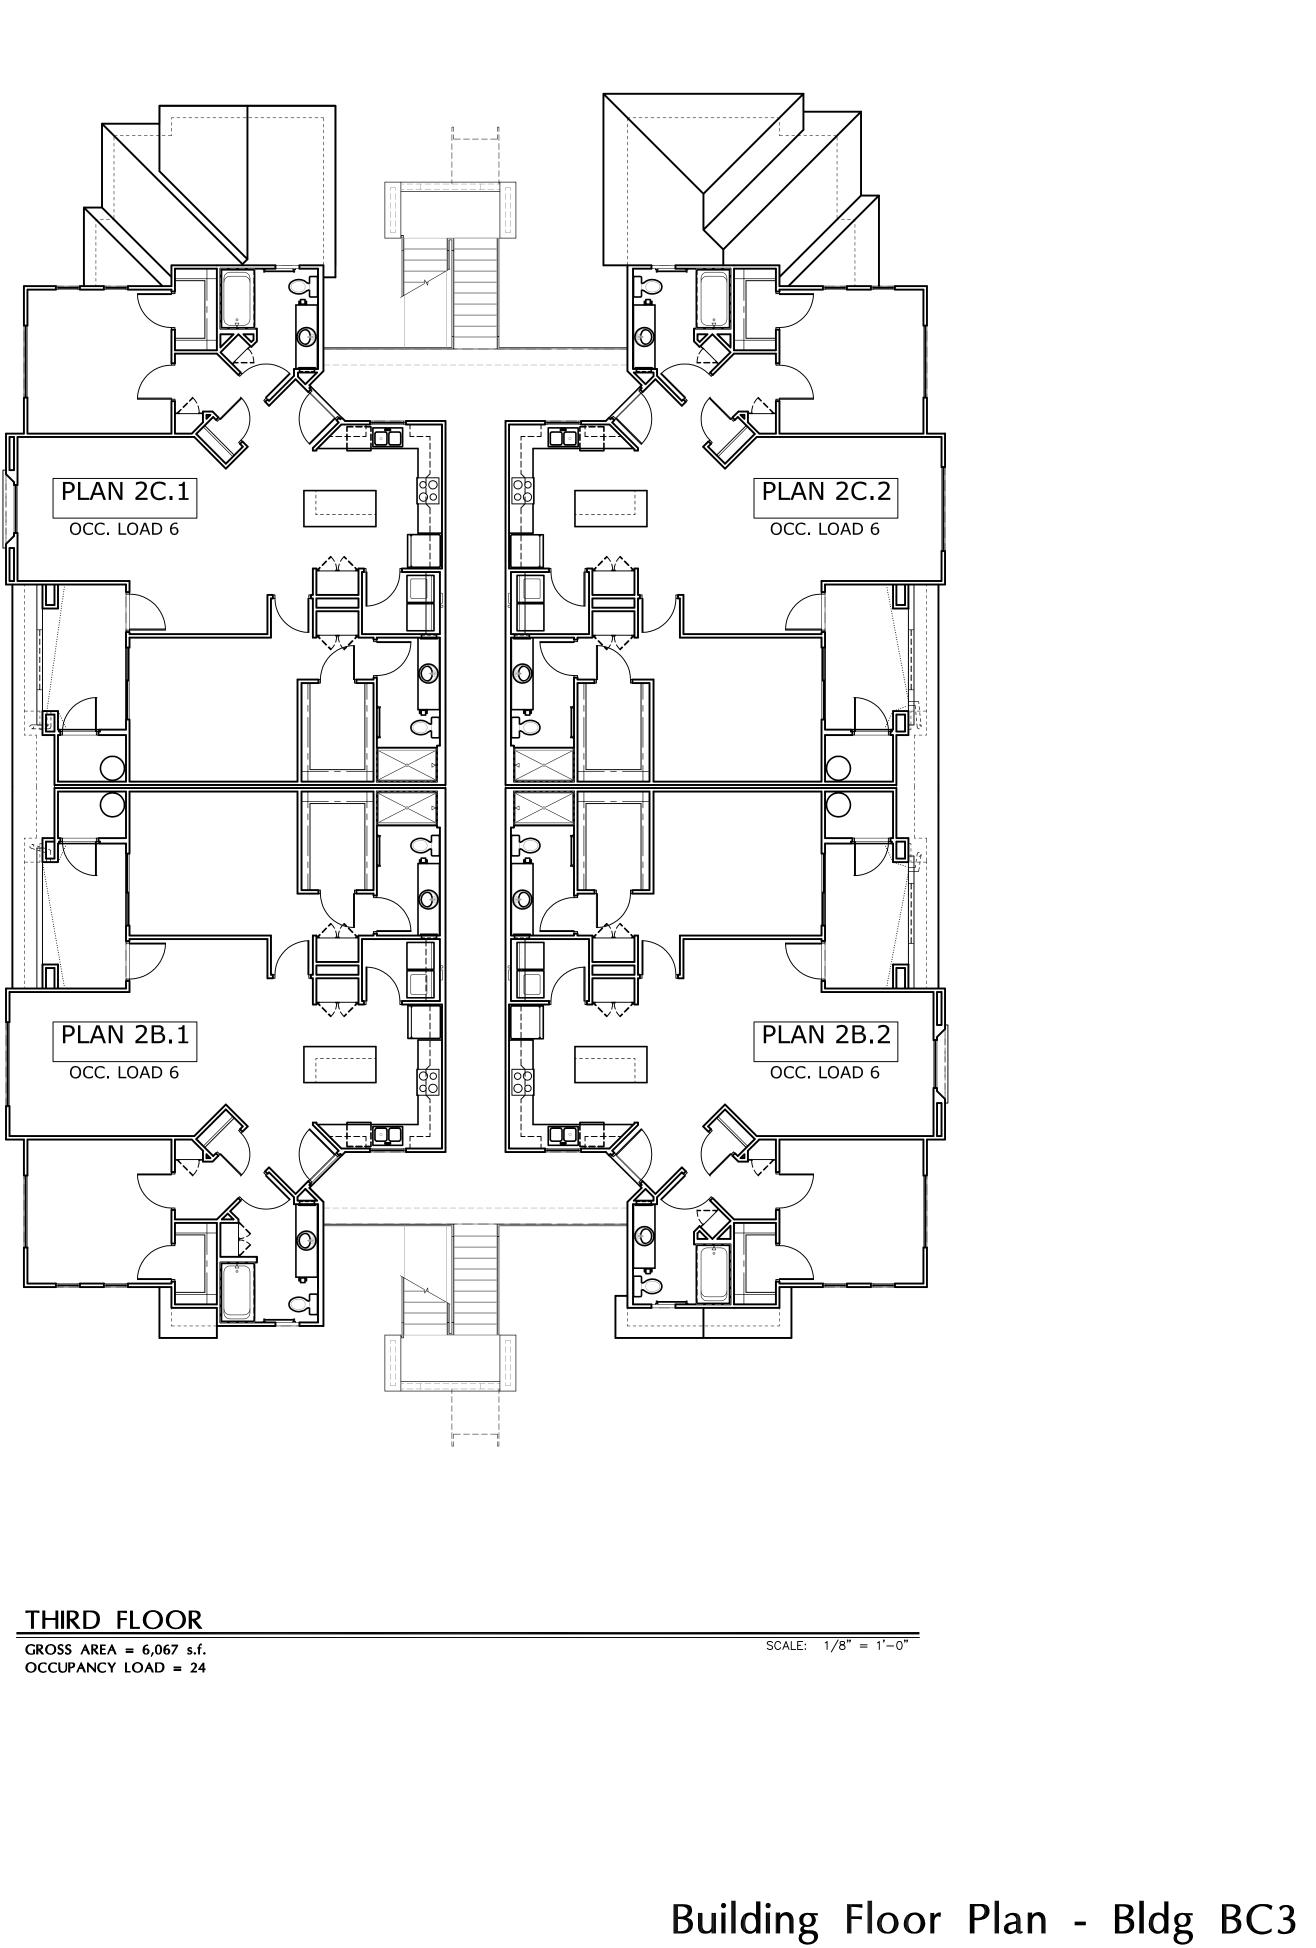

Owner BASELINE GATESWAY APTS LLC 6623 N. SCOTTSDALE ROAD SCOTTSDALE, AZ 85250 CONTACT: CHRIS BROZINA P: (480) 991–9111 Developer MARK-TAYLOR DEVELOPMENT 6623 N. SCOTTSDALE ROAD SCOTTSDALE, AZ 85250 CONTACT: CHRIS BROZINA P: (480) 991–9111 Applicant (GPA, Rezone) EARL, CURLEY, LAGARDE
3101 N. CENTRAL AVE. #1000 PHOENIX, AZ 85012 CONTACT: STEVE EARL P: (602) 265–0094
Image: Constant of the second systemImage: Constant of the second sy
<section-header><text><text></text></text></section-header>
Date: Scale: Drawn: Checked: Plan Check No:

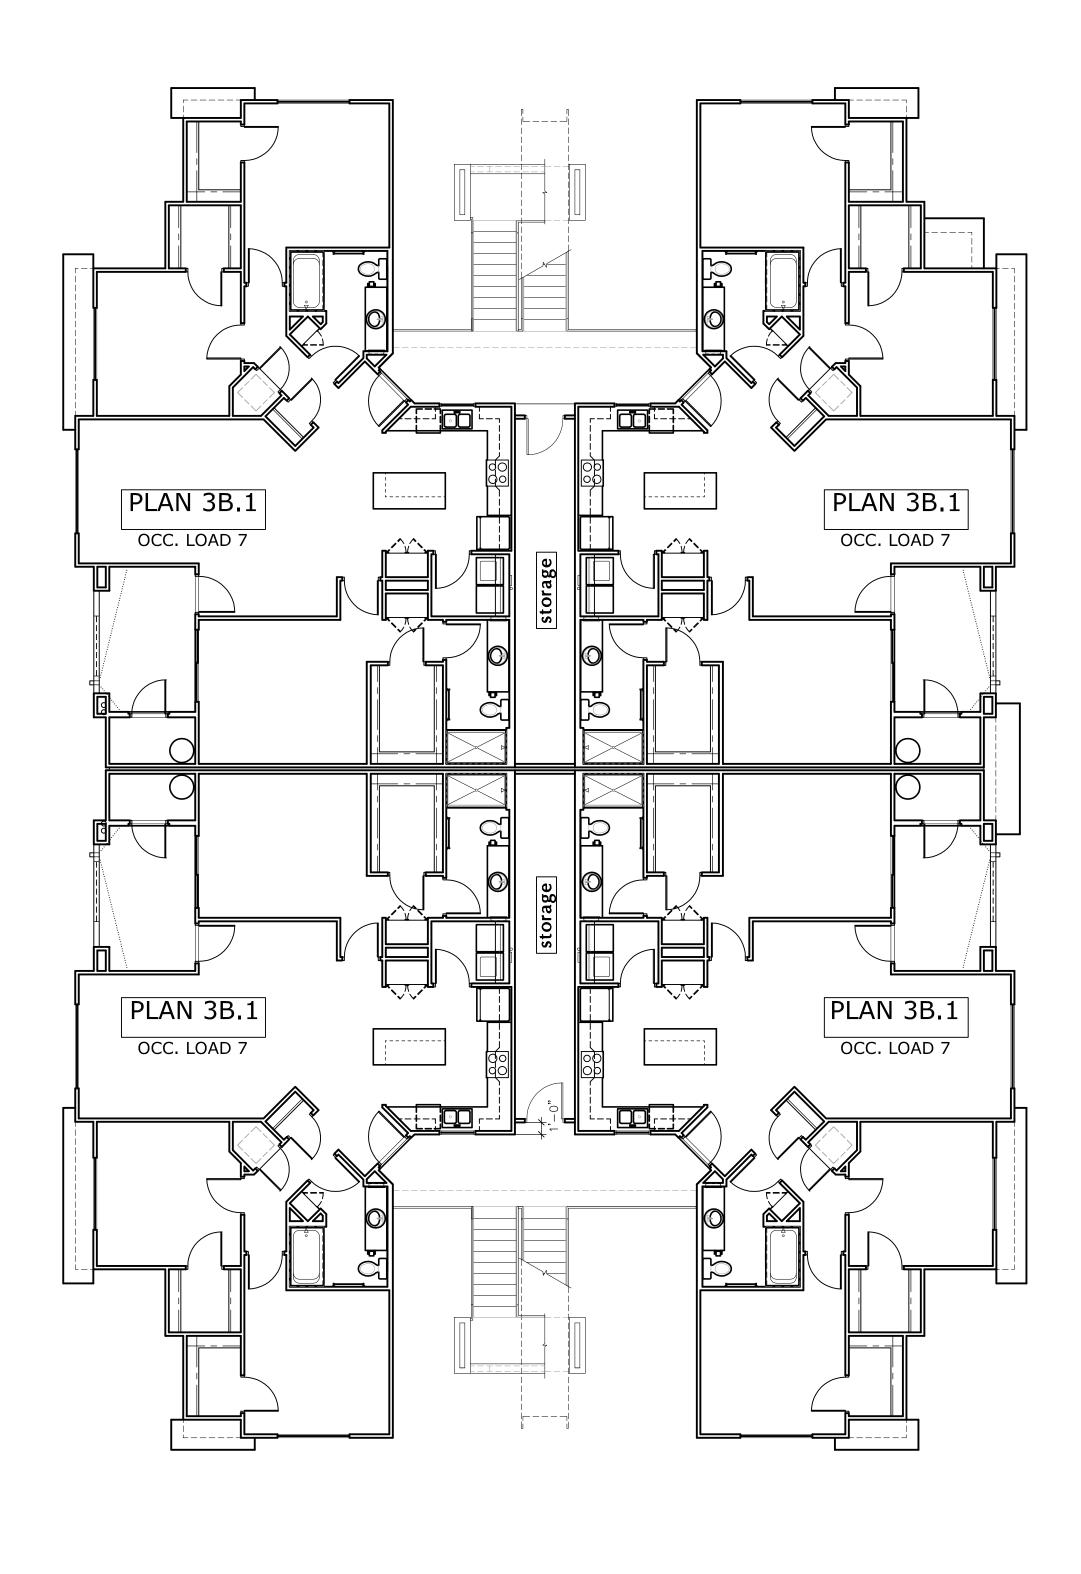

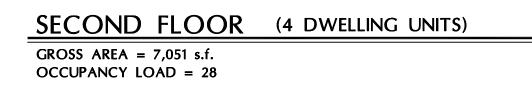

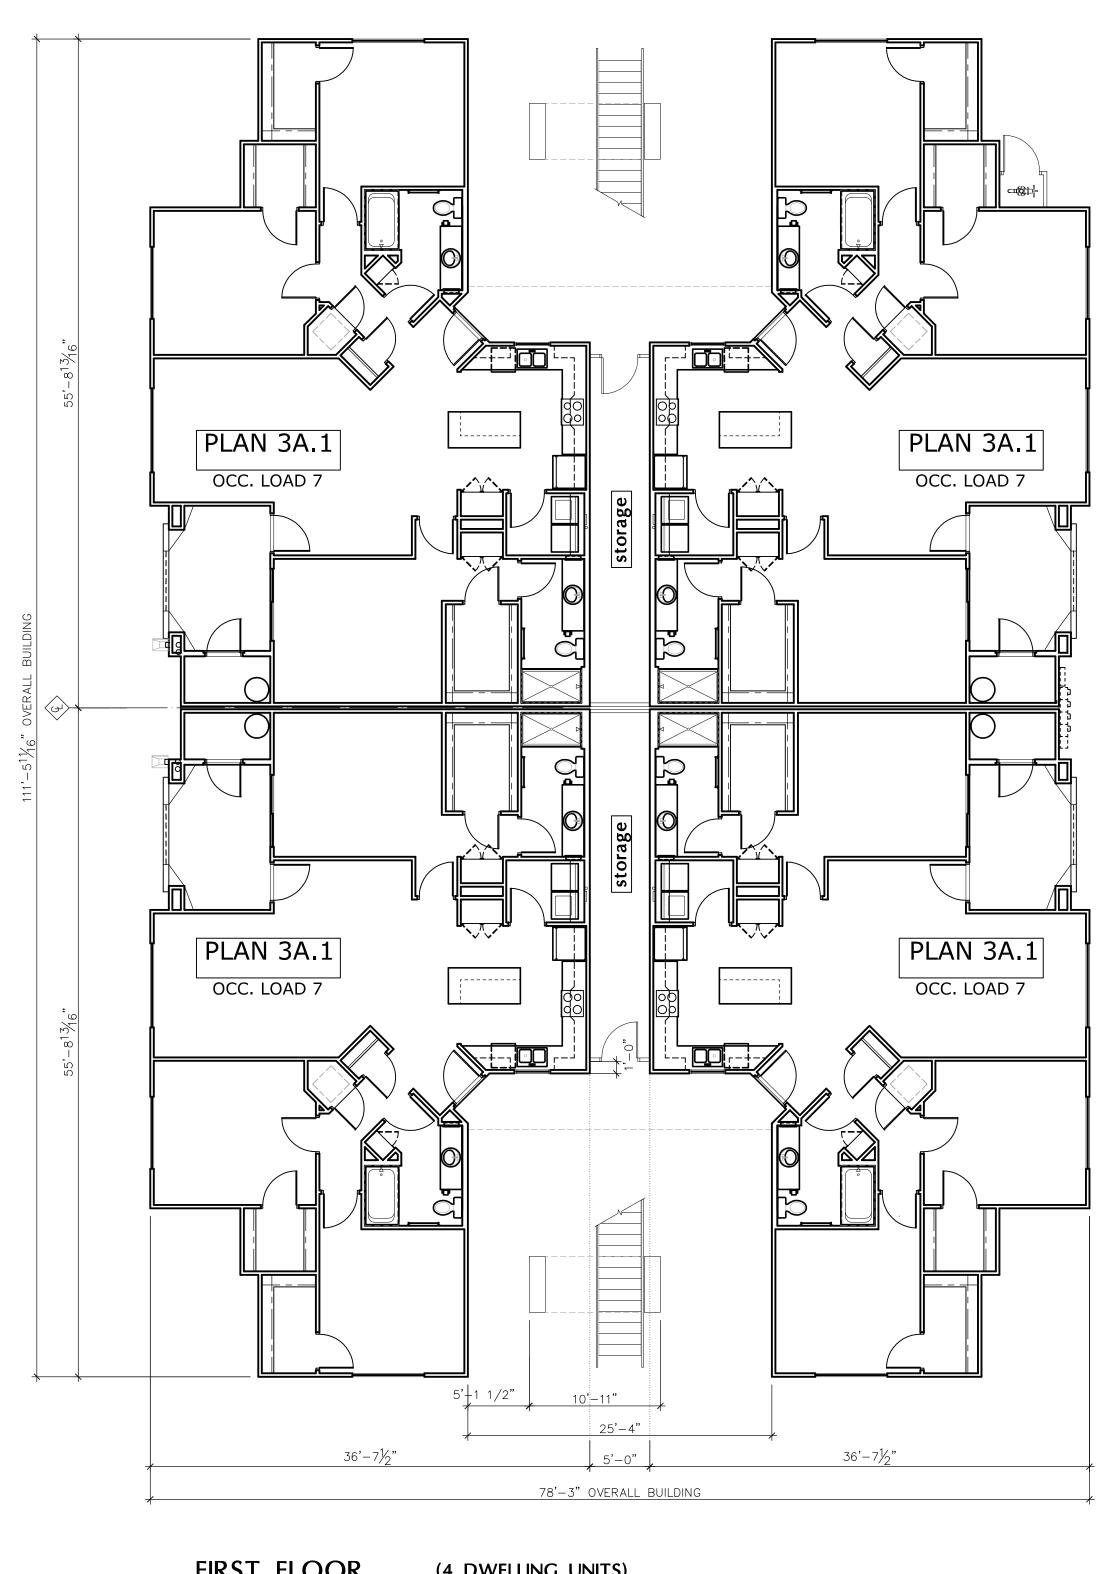

FIRST FLOOR(4 DWELLING UNITS)GROSS AREA = 7,193 s.f.<br/>OCCUPANCY LOAD = 28

SCALE: 1/8" = 1'-0"


ARCHITECTURAL DESIGN GROUP 6623 North Scottsdale Road Scottsdale, Az. 85250 480-991-9111 Owner BASELINE GATEWAY APTS. LLC 6623 N. SCOTTSDALE ROAD SCOTTSDALE, AZ 85250 CONTACT: CHRIS BROZINA P: (480) 991-9111 Developer MARK-TAYLOR DEVELOPMENT 6623 N. SCOTTSDALE ROAD SCOTTSDALE, AZ 85250 CONTACT: CHRIS BROZINA P: (480) 991-9111 Applicant (GPA, Rezone) EARL, CURLEY, LAGARDE 3101 N. CENTRAL AVE. #1000 PHOENIX, AZ 85012 CONTACT: STEVE EARL P: (602) 265-0094 00 M  $\bigcirc$ 5 O a O ī 2 2 2 0 0 1 0 0 1 0 ι <mark>Ν</mark> Ο - 00 -C ଟ ā  $\bigcirc$ tsd: 48( 0 2 **\_\_** ᆗ┛ Scot North ttsdale, 1-9111 <u>K</u>Z 6623 Scott (480) 991 ଟ  $\leq$ Civil Engineer 3–ENGINEERING 6370 E. THOMAS RD. Ste. 200 SCOTTSDALE, AZ 85251 CONTACT: DAN MANN P: (602) 334–4387 Architect ARCHITECTURAL DESIGN GROUP 6623 N. SCOTTSDALE RD. SCOTTSDALE, AZ 85250 CONTACT: ROB ORME P: (480) 281–5549 Landscape Arch't COLLABORATIVE-V DESIGN STUDIO 7116 E. 1ST. AVE. SUITE 103 SCOTTSDALE, AZ 85251 CONTACT: PAUL VECCHIA P: (480) 347-0590 ERED ARC 32220 ROB ORME )1/22/<sup>-</sup> Job No:

# Building Floor Plan - Bldg C3


SCALE: 1/8" = 1'-0"


Plan Check No:


Drawn: Checked: A6.1

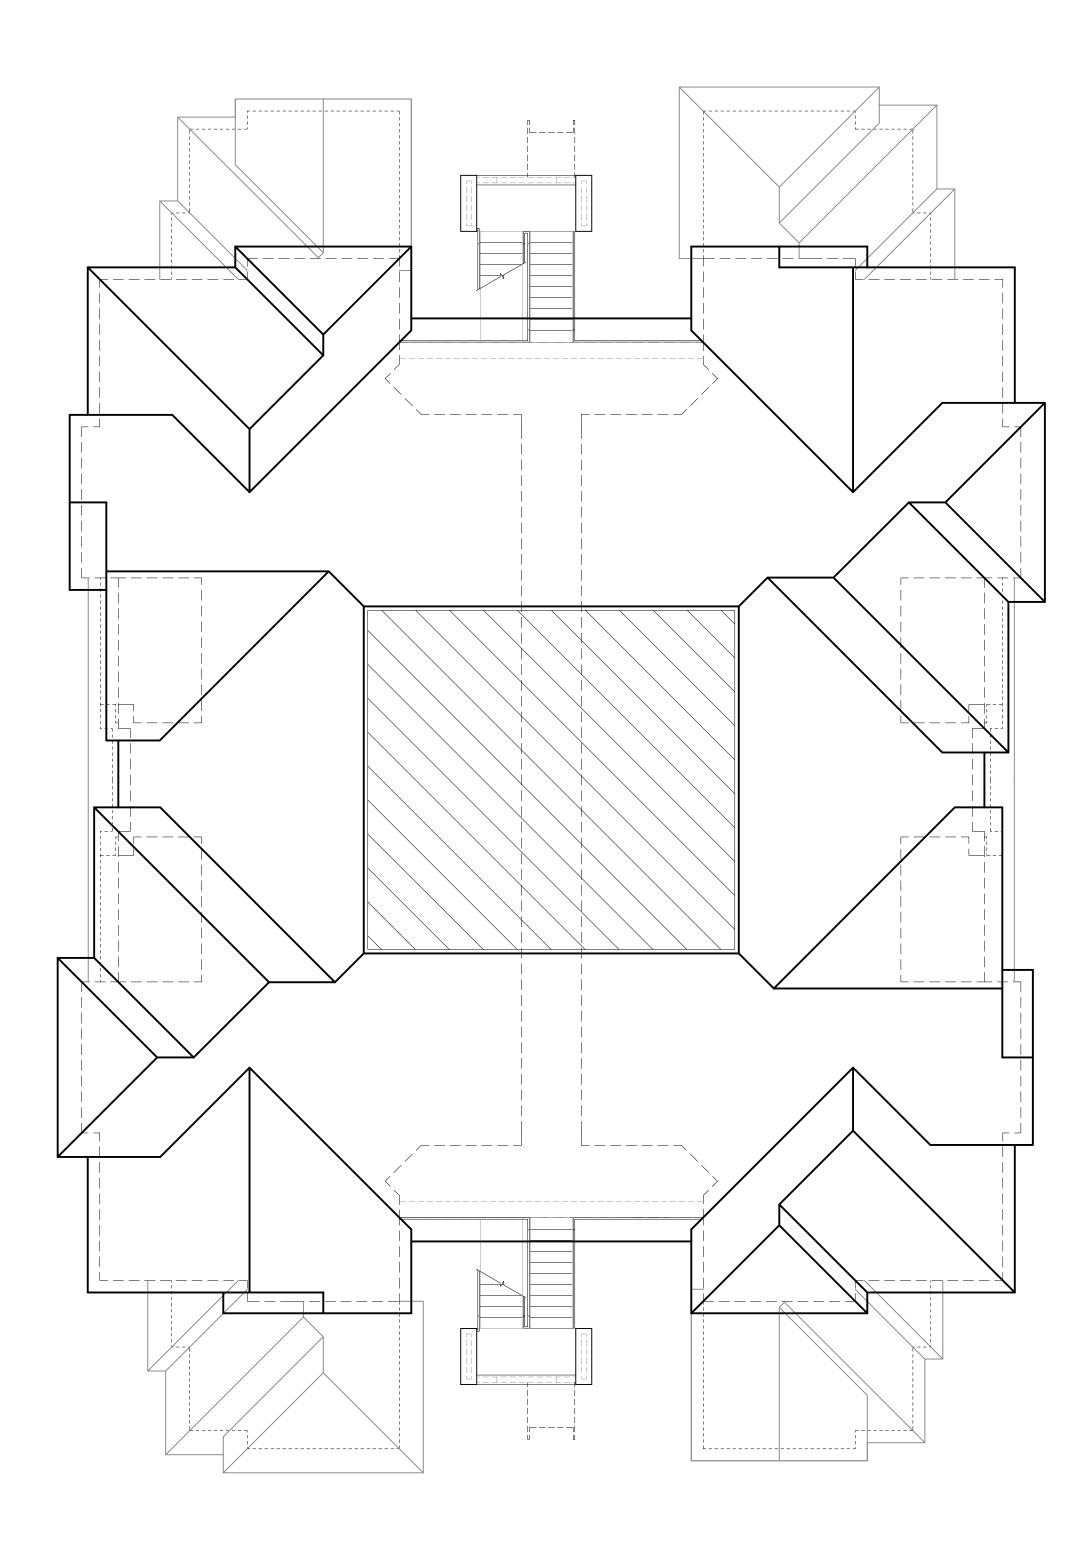

ROOF PLAN

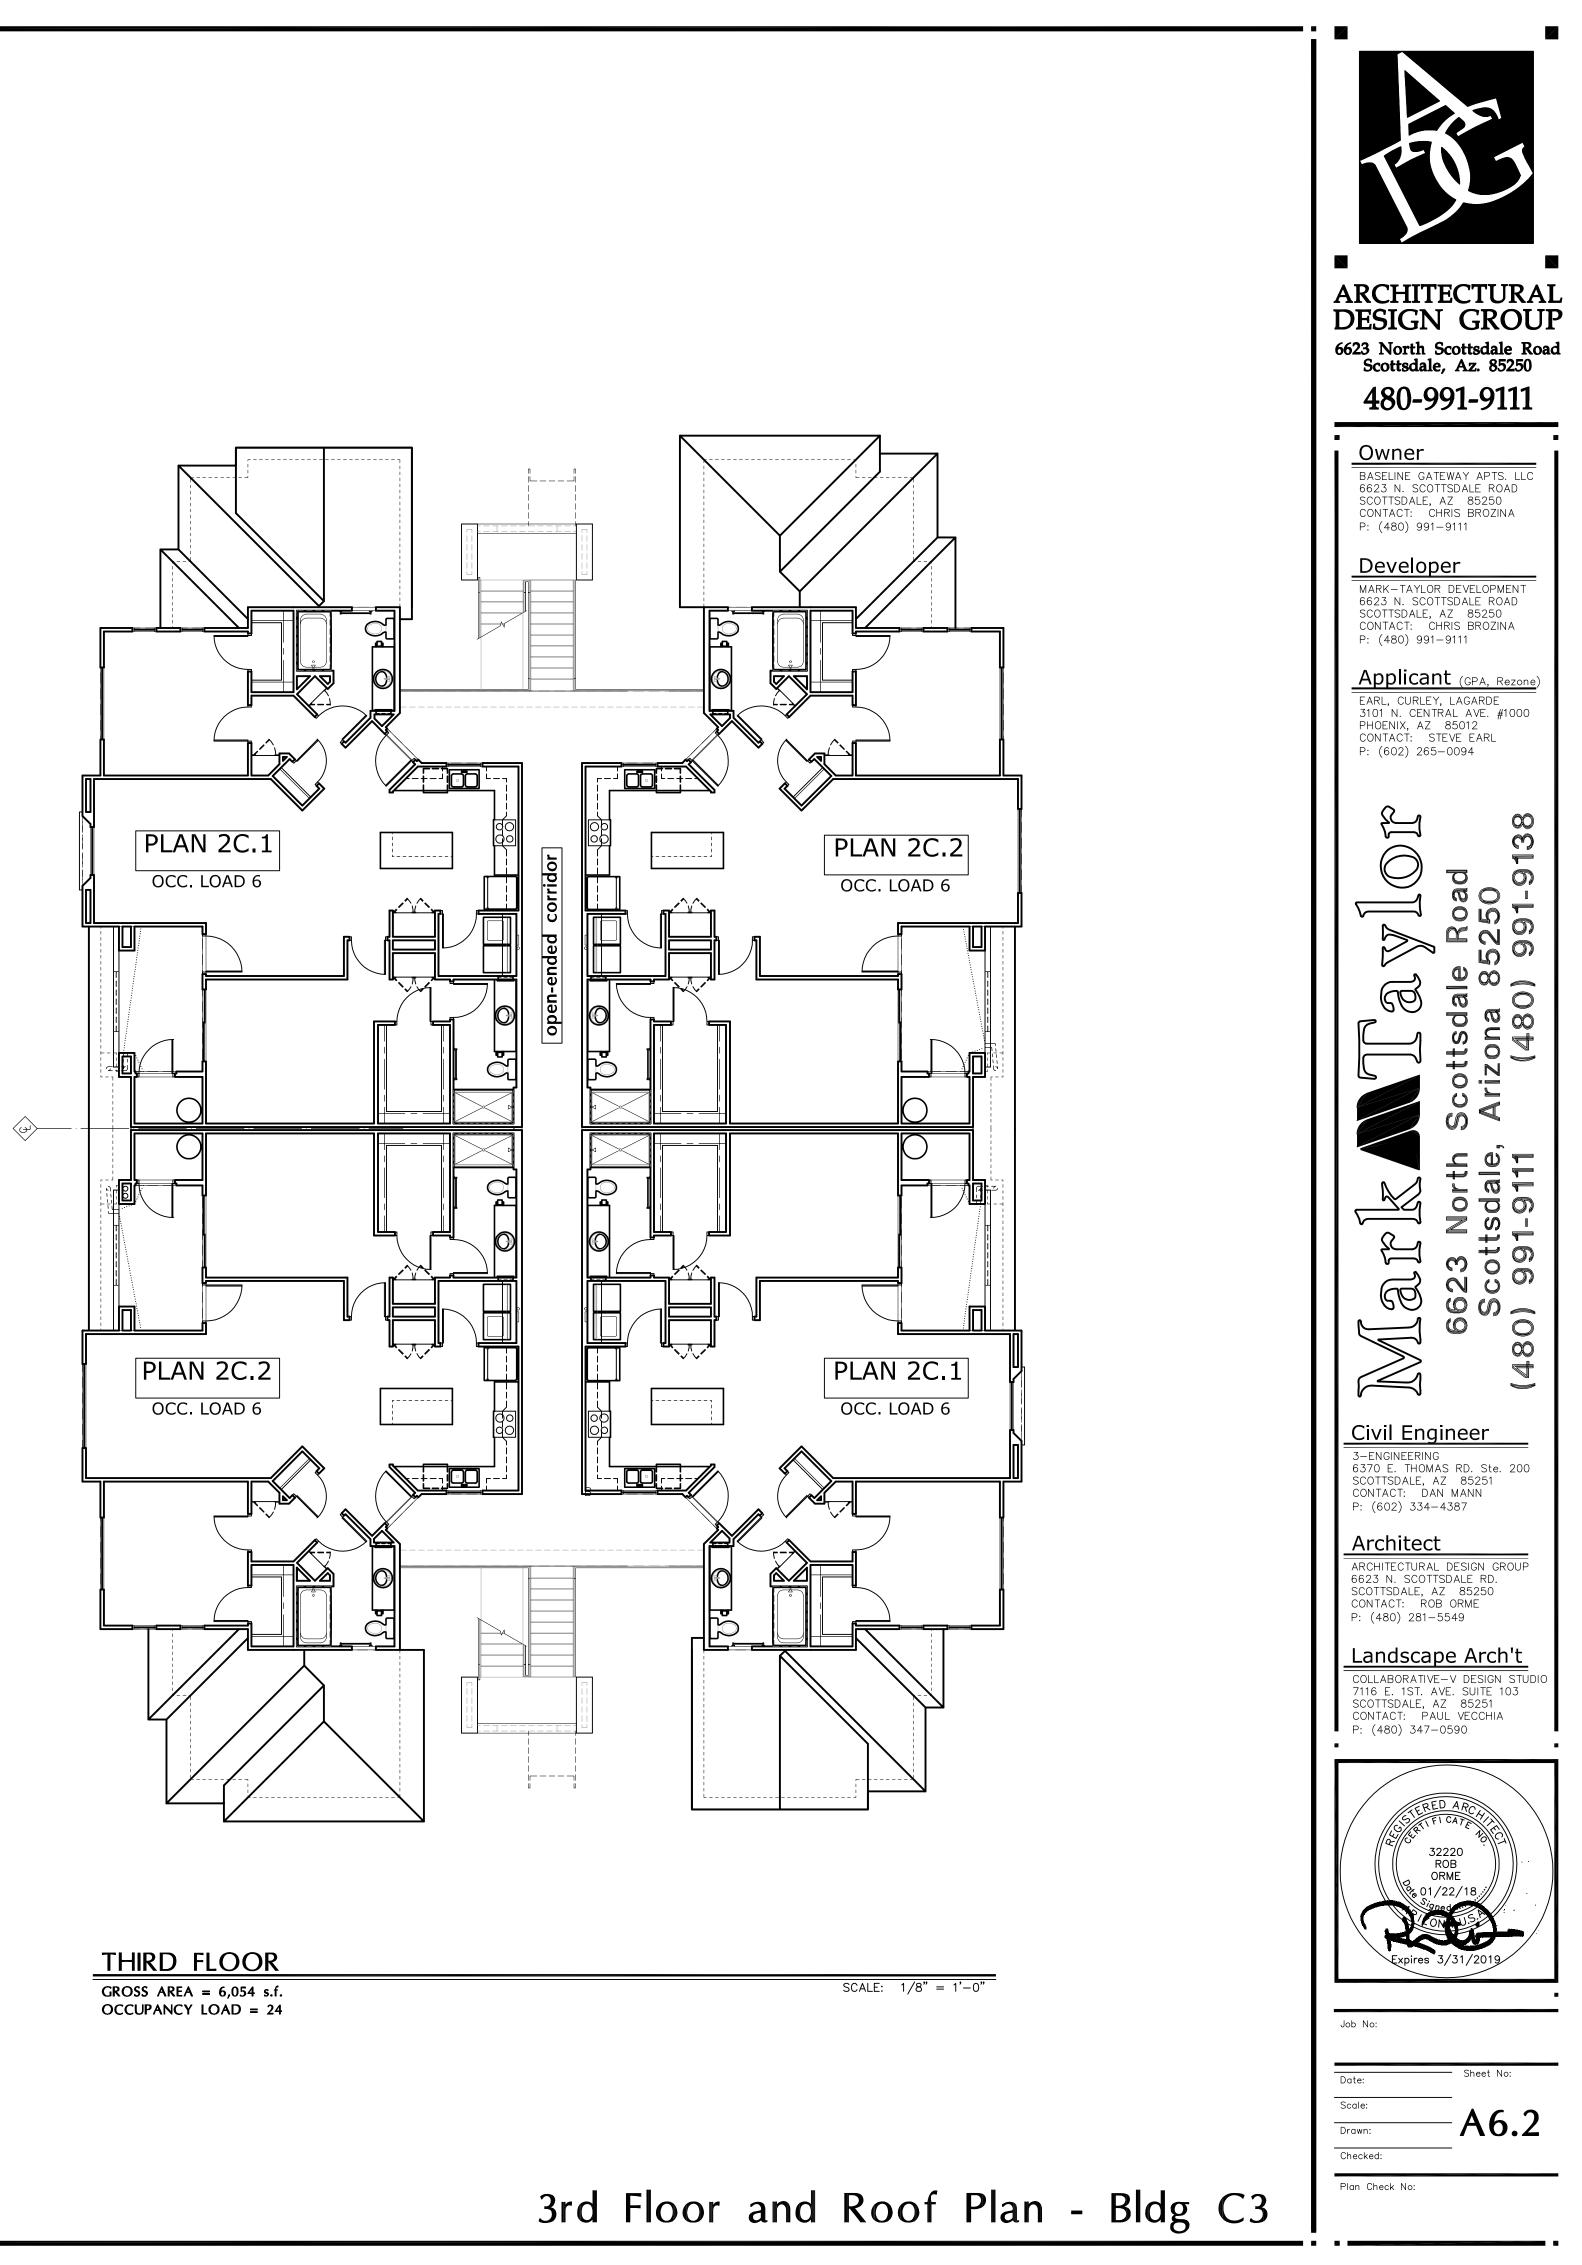

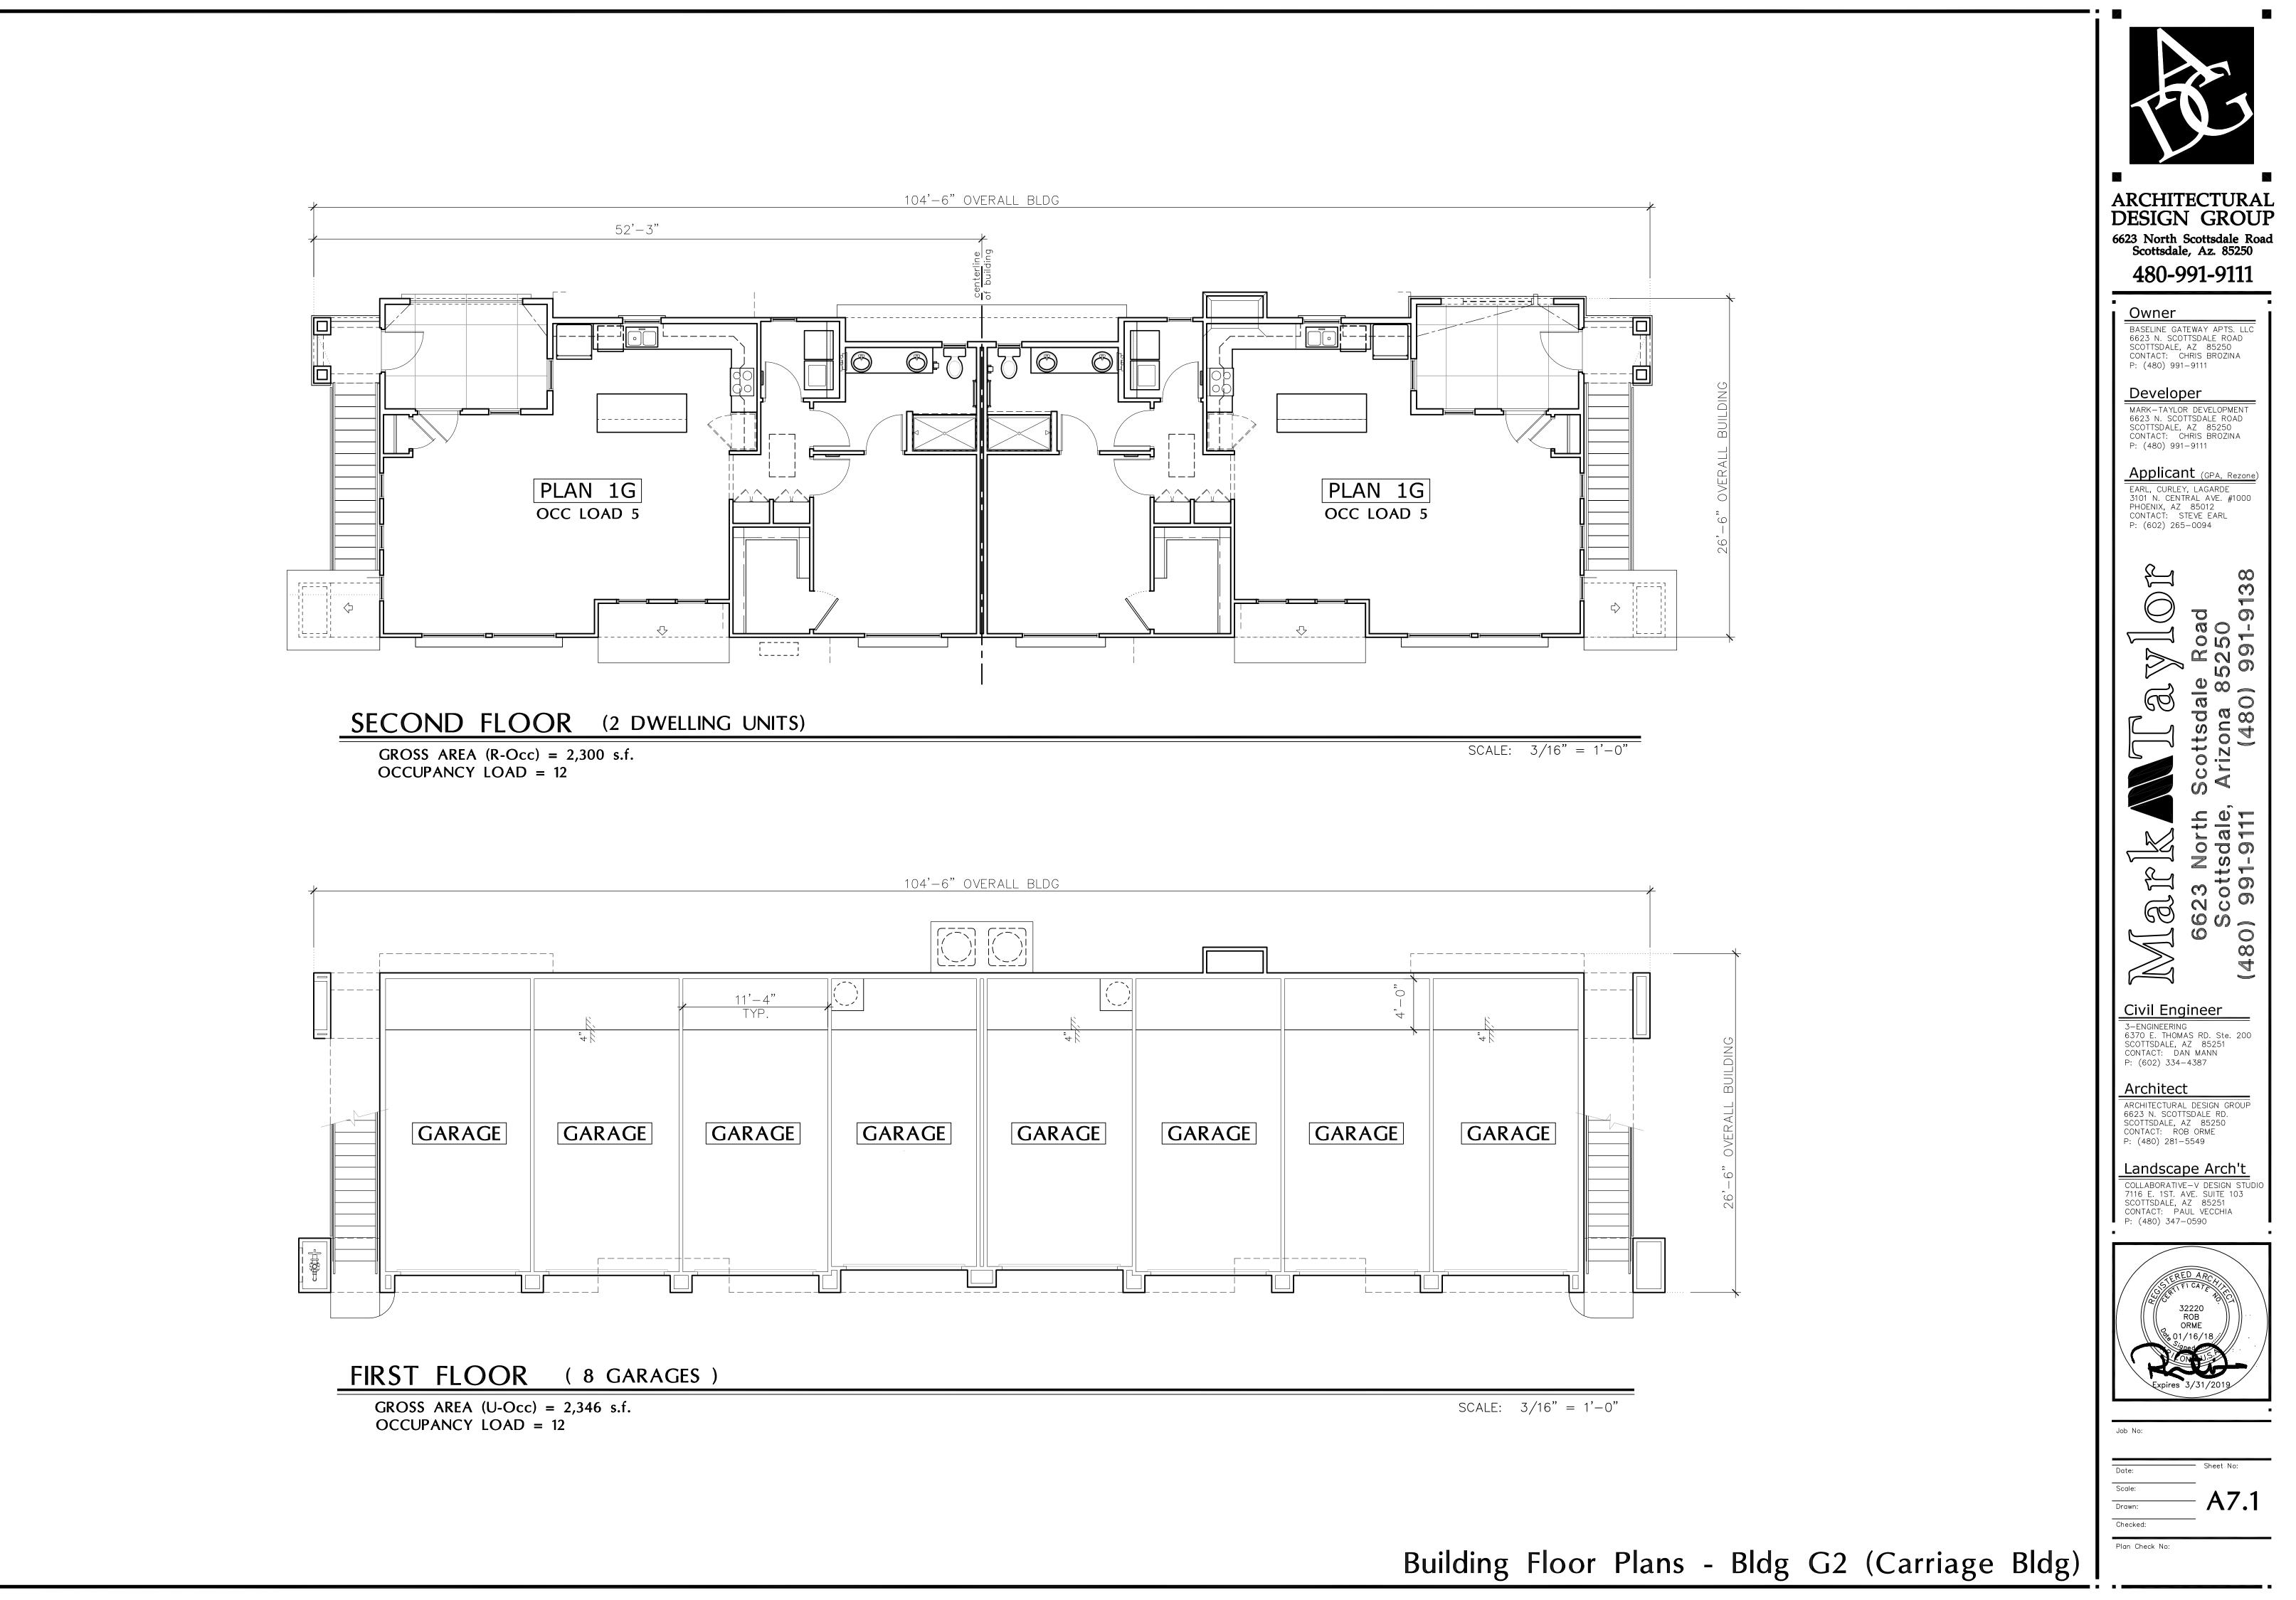


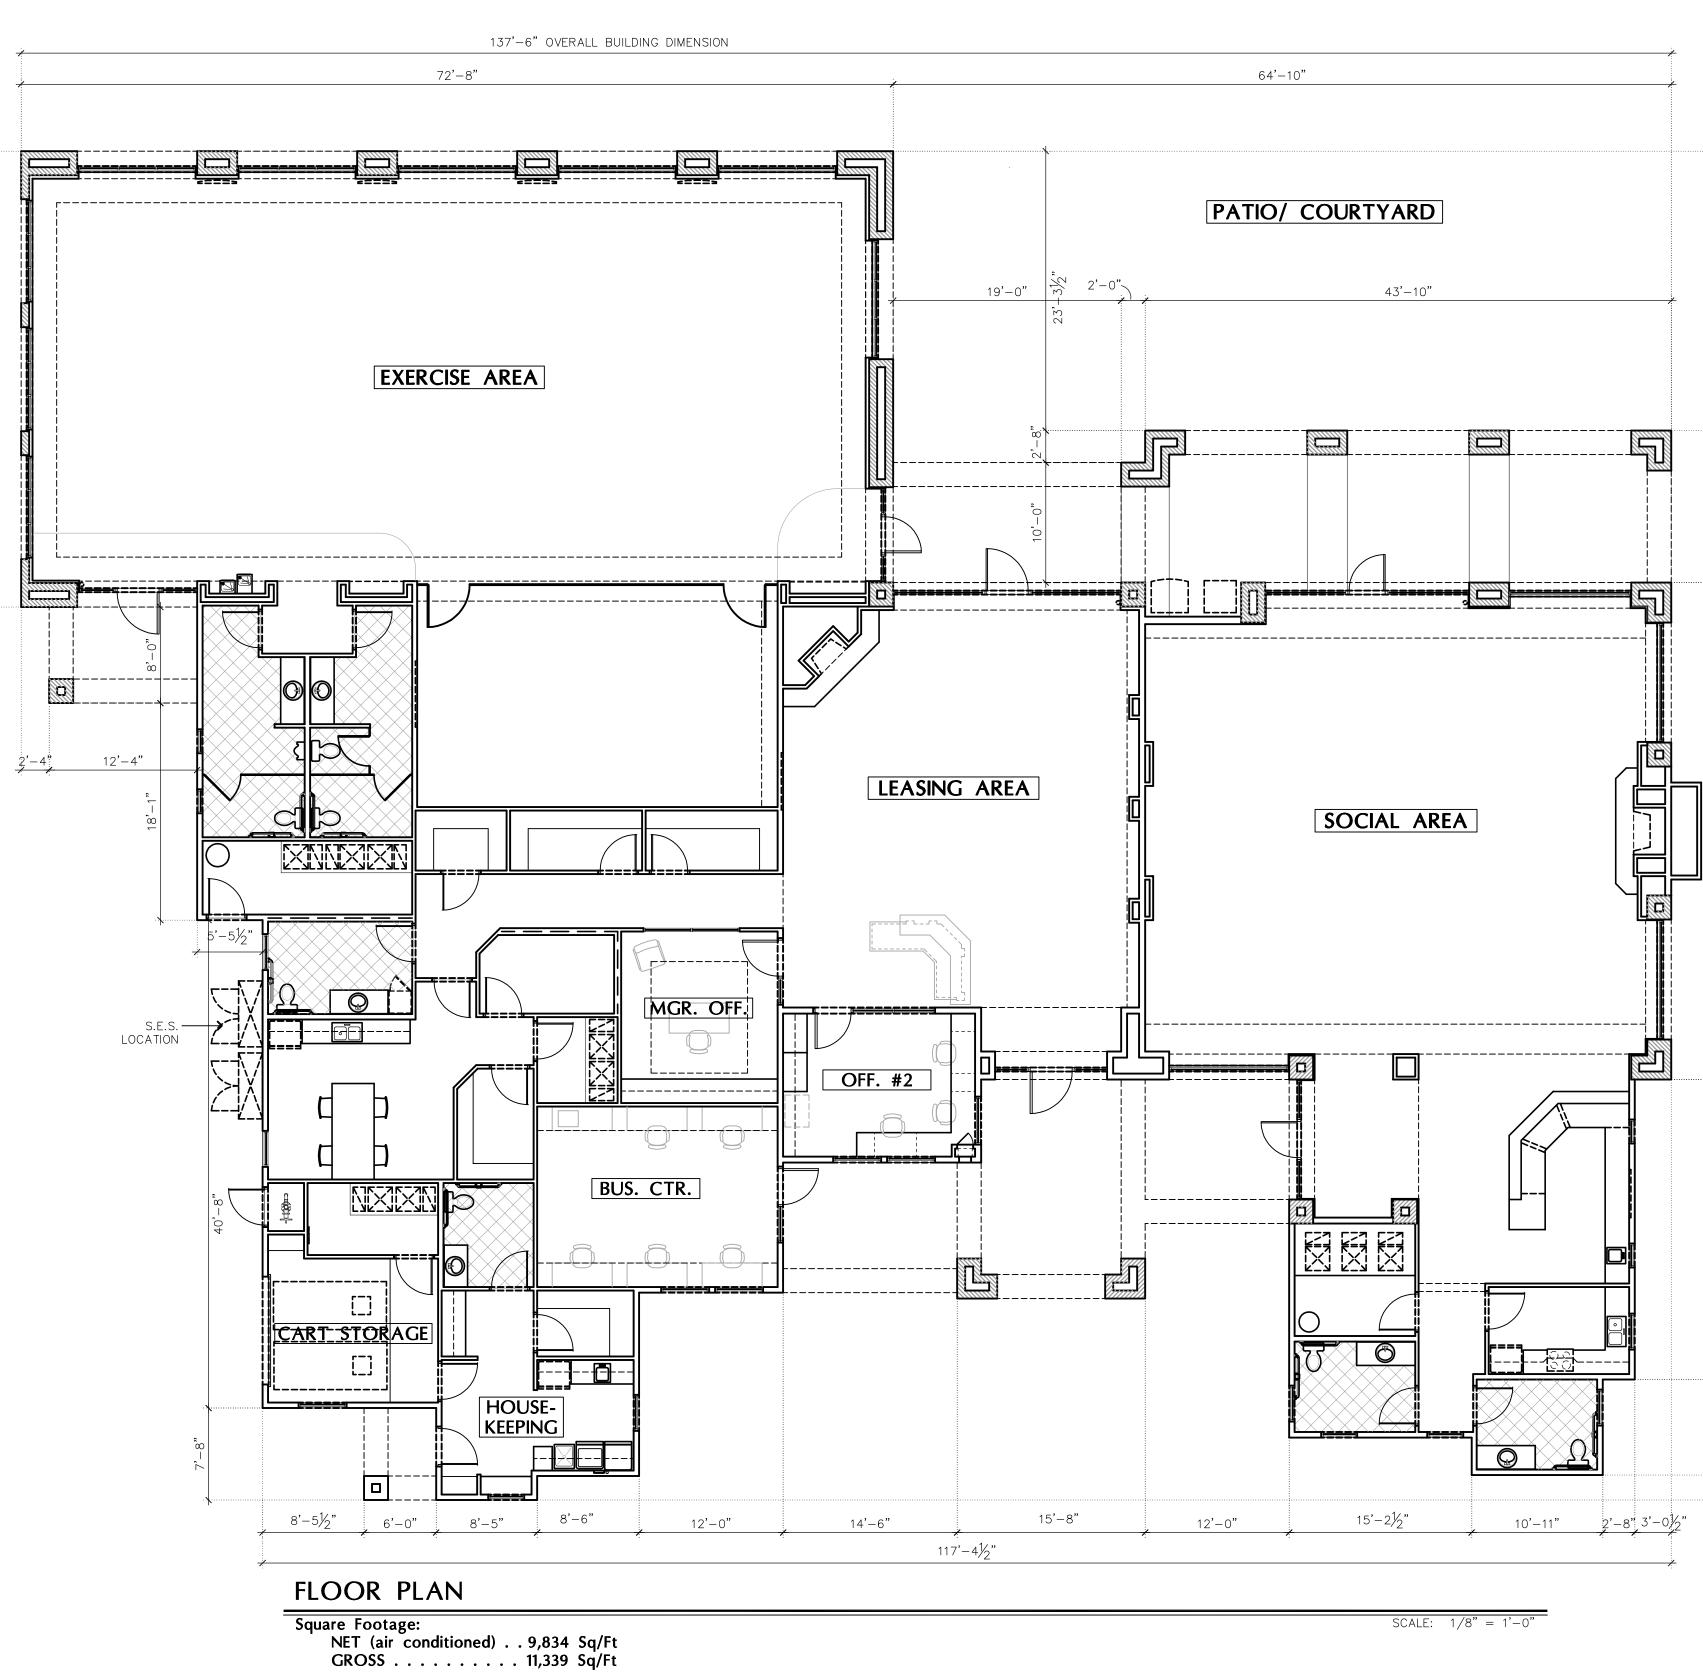


	•
	ARCHITECTURAL   DESIGN GROUP   6623 North Scottsdale Road   Scottsdale, Az. 85250
	480-991-9111
	Owner BASELINE GATEWAY APTS. LLC 6623 N. SCOTTSDALE ROAD SCOTTSDALE, AZ 85250 CONTACT: CHRIS BROZINA
	P: (480) 991–9111 Developer MARK-TAYLOR DEVELOPMENT 6623 N. SCOTTSDALE ROAD SCOTTSDALE, AZ 85250 CONTACT: CHRIS BROZINA D. (400) 0014
	P: (480) 991–9111 Applicant (gpa, rezone) EARL, CURLEY, LAGARDE 3101 N. CENTRAL AVE. #1000 PHOENIX, AZ 85012 CONTACT: STEVE EARL P: (602) 265–0094
	Image: Second
	ARCHITECTURAL DESIGN GROUP 6623 N. SCOTTSDALE RD. SCOTTSDALE, AZ 85250 CONTACT: ROB ORME P: (480) 281–5549 <b>Landscape Arch't</b> COLLABORATIVE-V DESIGN STUDIO 7116 E. 1ST. AVE. SUITE 103 SCOTTSDALE, AZ 85251 CONTACT: PAUL VECCHIA P: (480) 347–0590
	SSTERED ARCA SSTERED ARCA SSTERED ARCA BE 32220 ROB ORME Be 01/16/18 Signed ONUS Expires 3/31/2019
	Job No: Date: Scale: Drawn: A8.1
nity Building	Drawn: A8.1 Checked: Plan Check No:

	k.		
12'-8"			
16'-8"	×		5 DIMENSION
, 1 ,	×	41'-5"	112'-5" OVERALL BUILDING DIMENSION
	16'-8"		~~~~~~~~~~~~~~~~~~~~~~~~~~~~~~~~~~~~~~
		25'-0"	
		7'-11½"	\$* \$*

## Floor Plan - Ameni

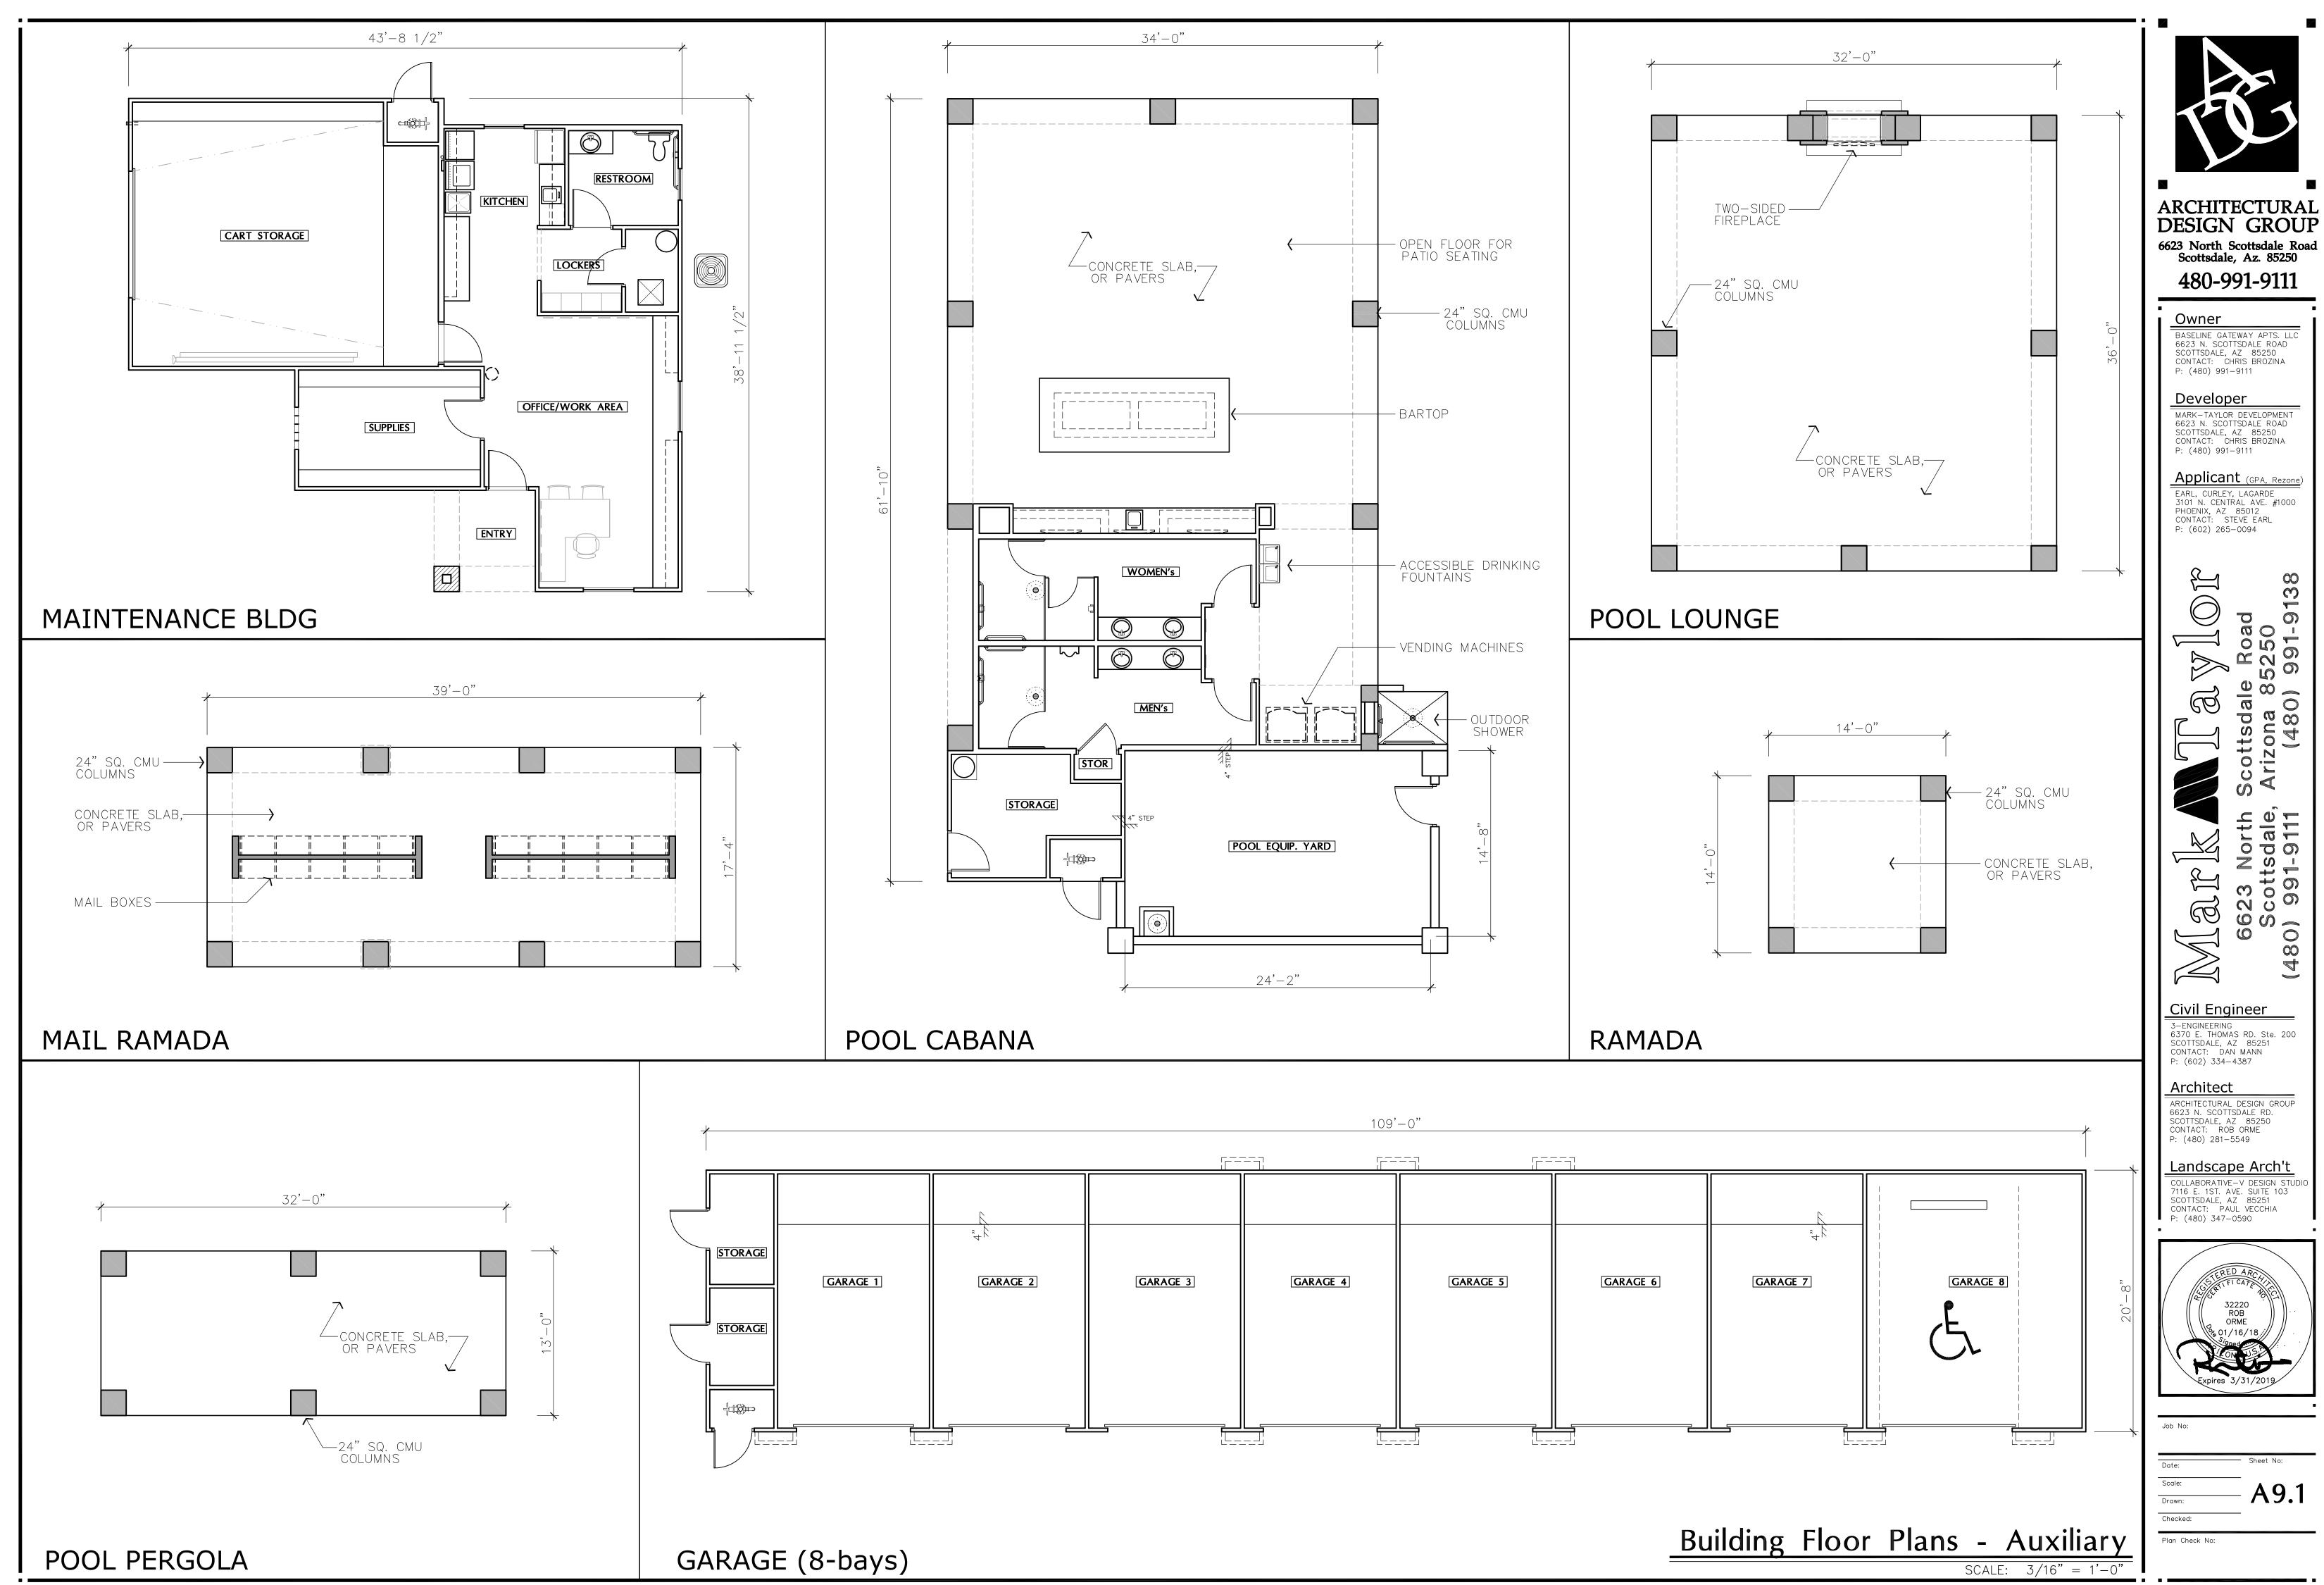

J:\9999 - Mesa-Baseline-ASSEMBLAGE\EXHIBITS\DRB\CAD\008-Auxiliary Bldgs-DRB.dwg, 1/16/2018 11:48:51 AM

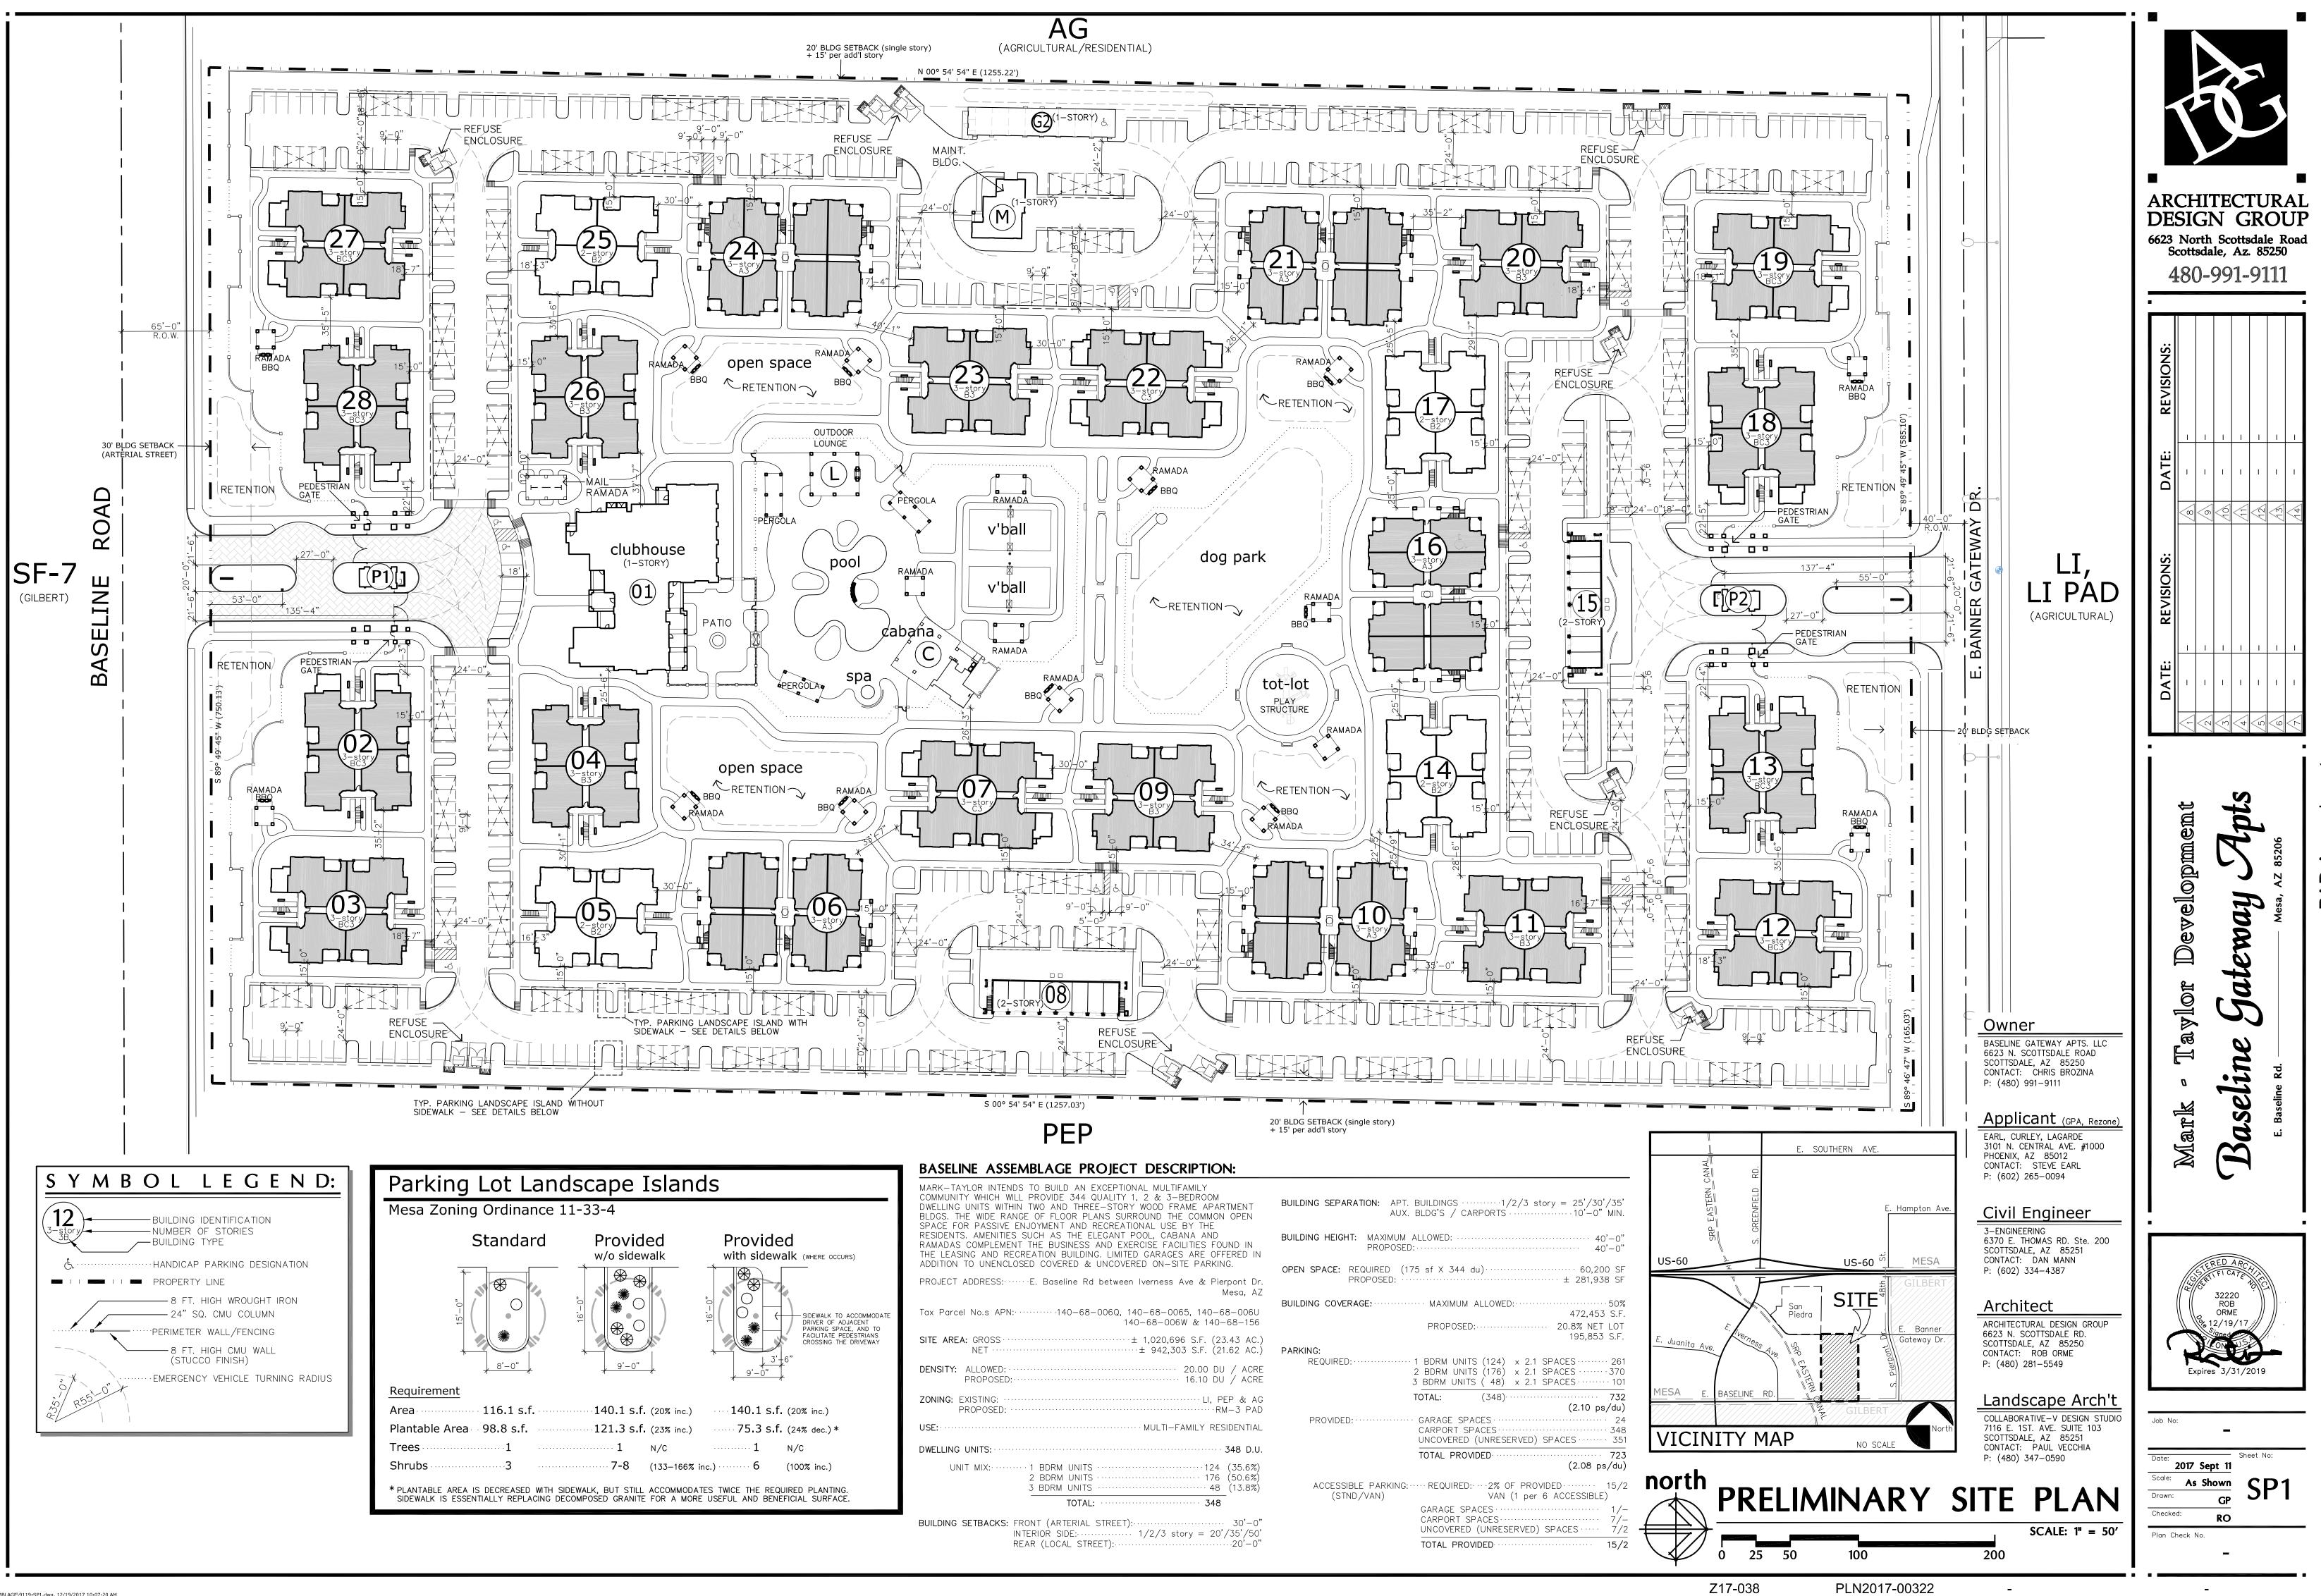


vided idewalk (WHERE OCCURS)	
SIDEWALK TO ACCOMMODATE DRIVER OF ADJACENT PARKING SPACE, AND TO FACILITATE PEDESTRIANS CROSSING THE DRIVEWAY	
↓ <u>3'</u> 6" -0" ↓	
<b>1 s.f.</b> (20% inc.)	
3 <b>s.f.</b> (24% dec.)*	
N/C	
5 (100% inc.)	
E REQUIRED PLANTING.	


-TAYLOR INTENDS TO BUILD AN EXCEPTIONAL MULTIFAMILY
UNITY WHICH WILL PROVIDE 344 QUALITY 1, 2 & 3-BEDROOM
ING UNITS WITHIN TWO AND THREE-STORY WOOD FRAME APARTMEN
5. THE WIDE RANGE OF FLOOR PLANS SURROUND THE COMMON OPE
FOR PASSIVE ENJOYMENT AND RECREATIONAL USE BY THE

BLDGS. THE WIDE RANGE OF FLOOR PLANS SURROUND THE COMMON OPEN SPACE FOR PASSIVE ENJOYMENT AND RECREATIONAL USE BY THE RESIDENTS. AMENITIES SUCH AS THE ELEGANT POOL, CABANA AND RAMADAS COMPLEMENT THE BUSINESS AND EXERCISE FACILITIES FOUND IN THE LEASING AND RECREATION BUILDING. LIMITED GARAGES ARE OFFERED IN ADDITION TO UNENCLOSED COVERED & UNCOVERED ON-SITE PARKING.	В
PROJECT ADDRESS: ······E. Baseline Rd between Iverness Ave & Pierpont Dr. Mesa, AZ	В
Tax Parcel No.s APN:	D
SITE AREA: GROSS ± 1,020,696 S.F. (23.43 AC.) NET ± 942,303 S.F. (21.62 AC.)	Ρ
DENSITY: ALLOWED: 20.00 DU / ACRE PROPOSED: 16.10 DU / ACRE	
ZONING: EXISTING:	
USE:	
DWELLING UNITS: 348 D.U.	
UNIT MIX:·······1 BDRM UNITS ··········124 (35.6%) 2 BDRM UNITS ········176 (50.6%) 3 BDRM UNITS ·······48 (13.8%)	
TOTAL:	

BUILDING SEPARATION: APT. BUILDINGS1/2/3 story = 25', AUX. BLDG'S / CARPORTS10'-	/30', -0"
BUILDING HEIGHT: MAXIMUM ALLOWED: PROPOSED:	· 40' 40'
OPEN SPACE:   REQUIRED   (175 sf X 344 du)   60     PROPOSED:   ± 28	),200 1,938
BUILDING COVERAGE: MAXIMUM ALLOWED: 472,	
PROPOSED: 20.8% 195,	
PARKING: REQUIRED:	· · · · · · ·
TOTAL: (348) (2.10	) ps/
PROVIDED: ······ GARAGE SPACES ······ CARPORT SPACES ····· UNCOVERED (UNRESERVED) SPACES ····	· · · · · · ·
TOTAL PROVIDED (2.08	 3 ps,
ACCESSIBLE PARKING:····· REQUIRED:····2% OF PROVIDED······ (STND/VAN) VAN (1 per 6 ACCESSI	
GARAGE SPACES ······ CARPORT SPACES ······ UNCOVERED (UNRESERVED) SPACES ··	····
TOTAL PROVIDED	

Am PAD

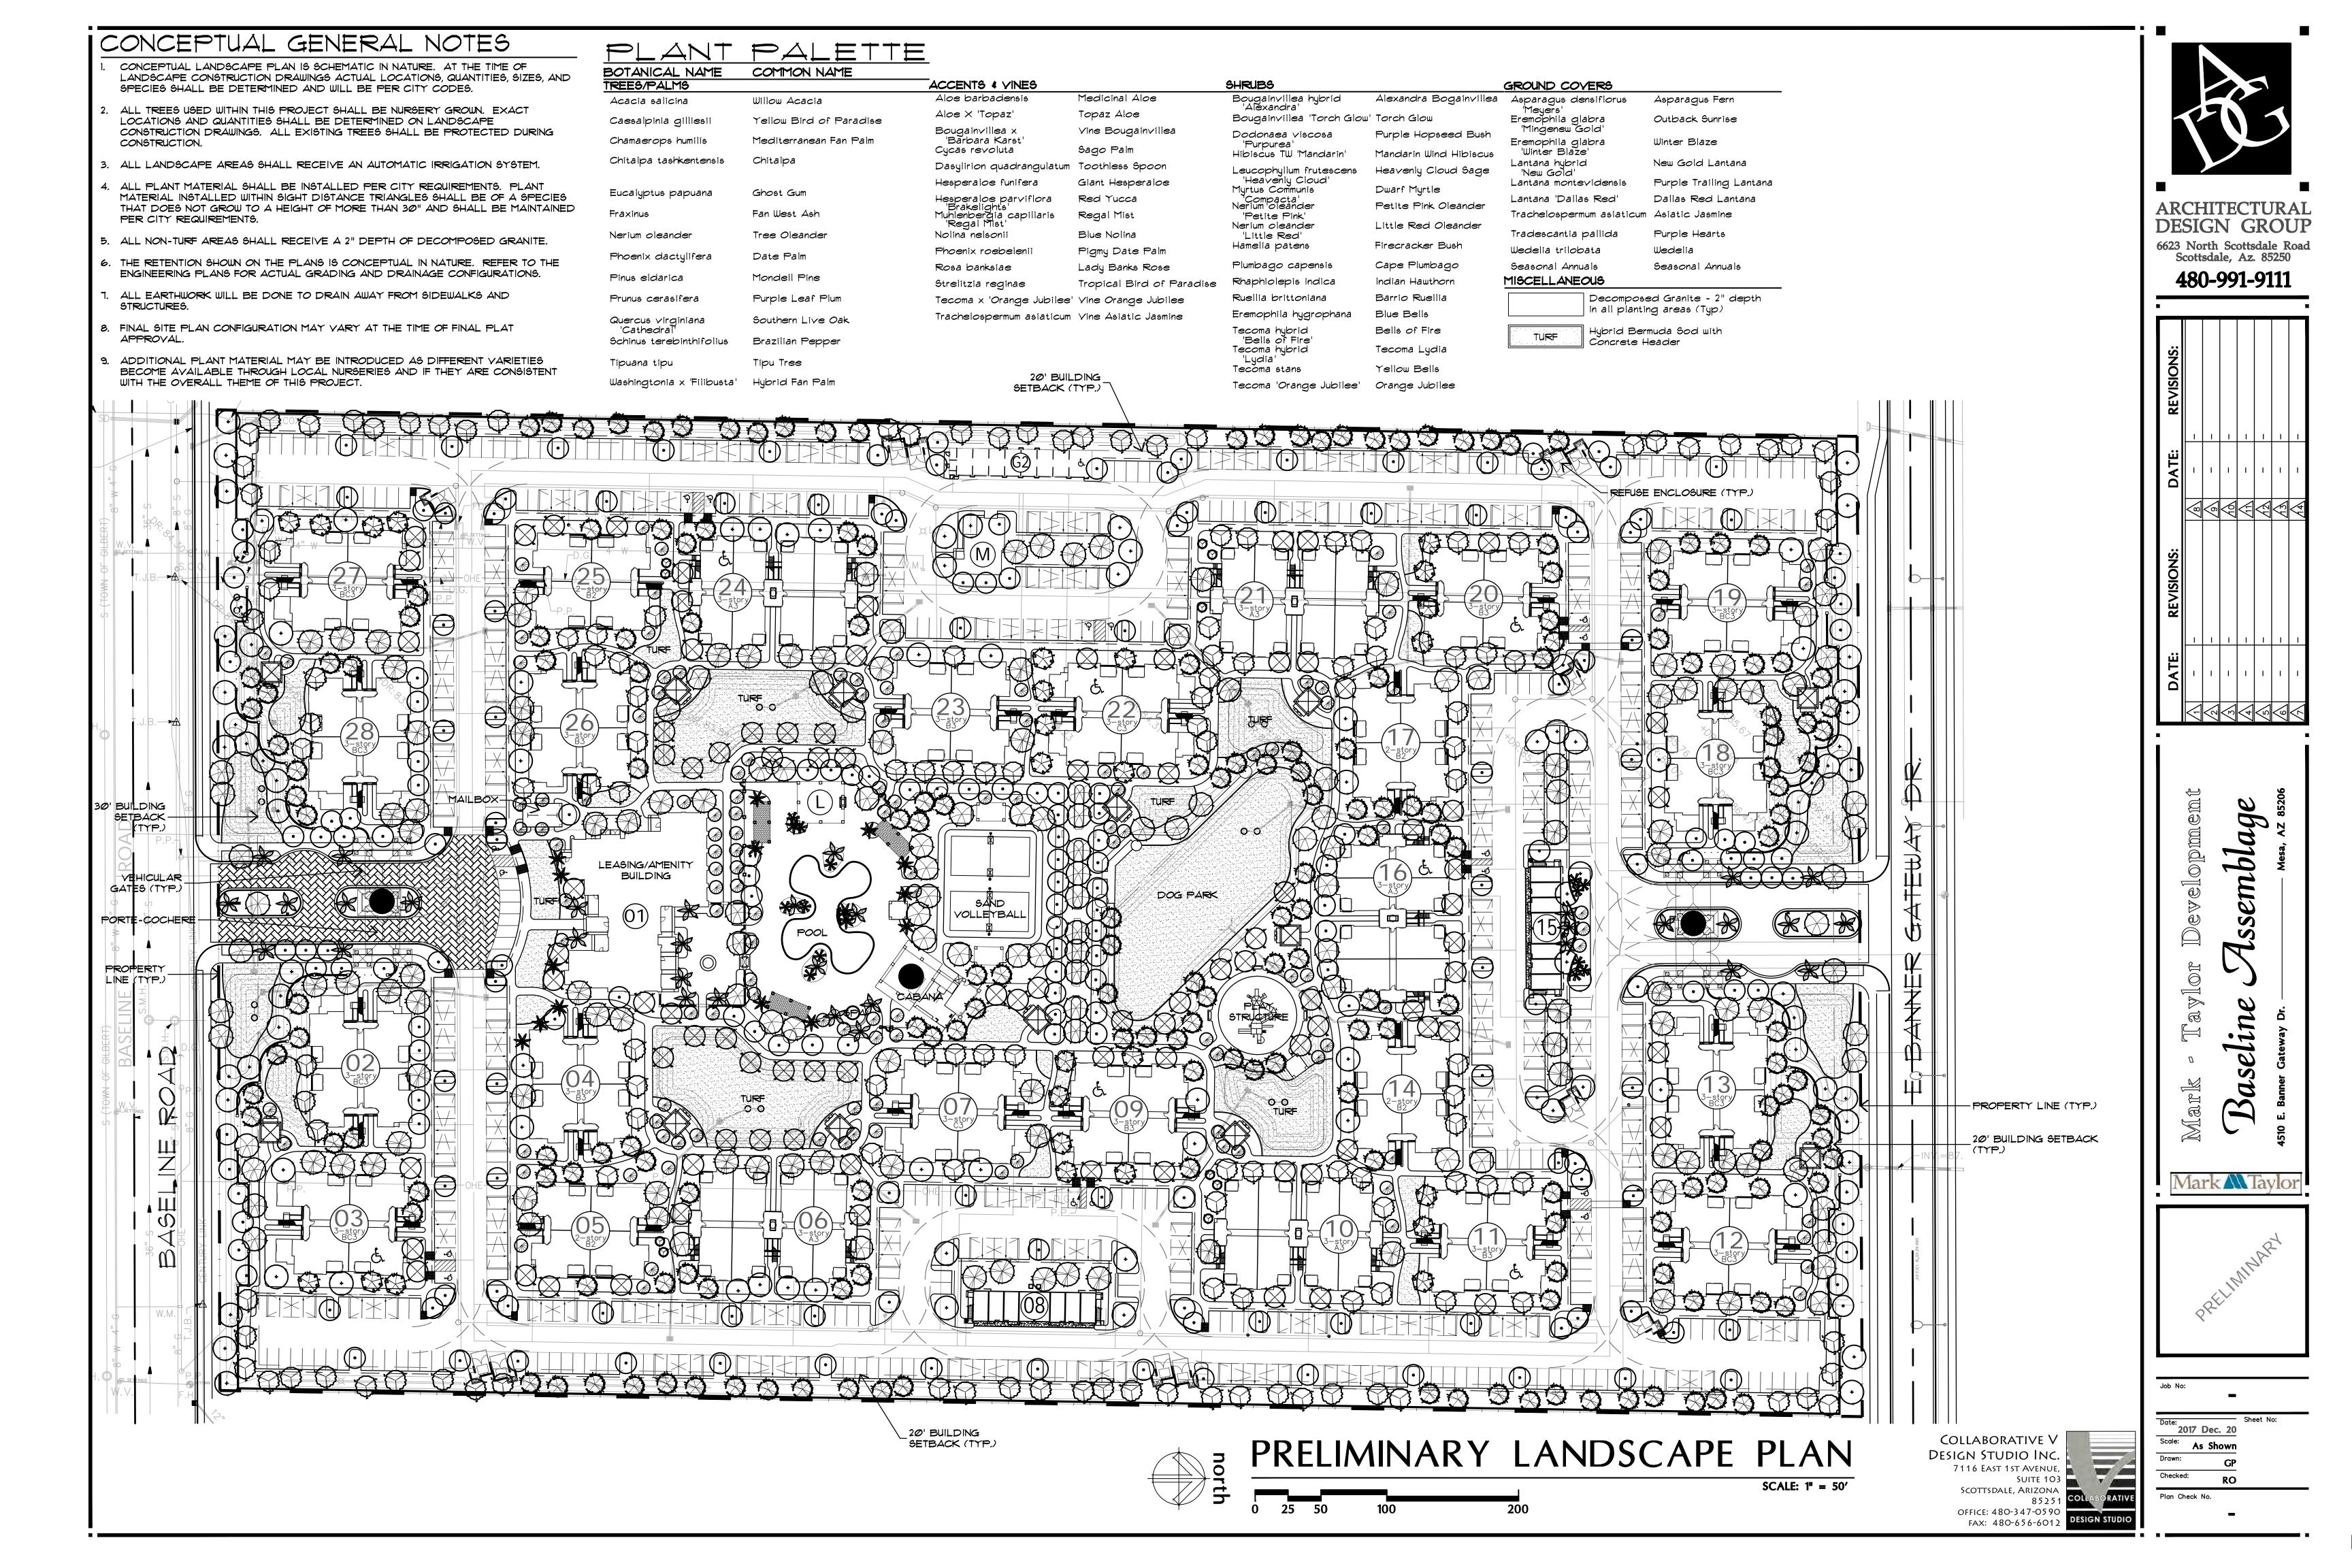

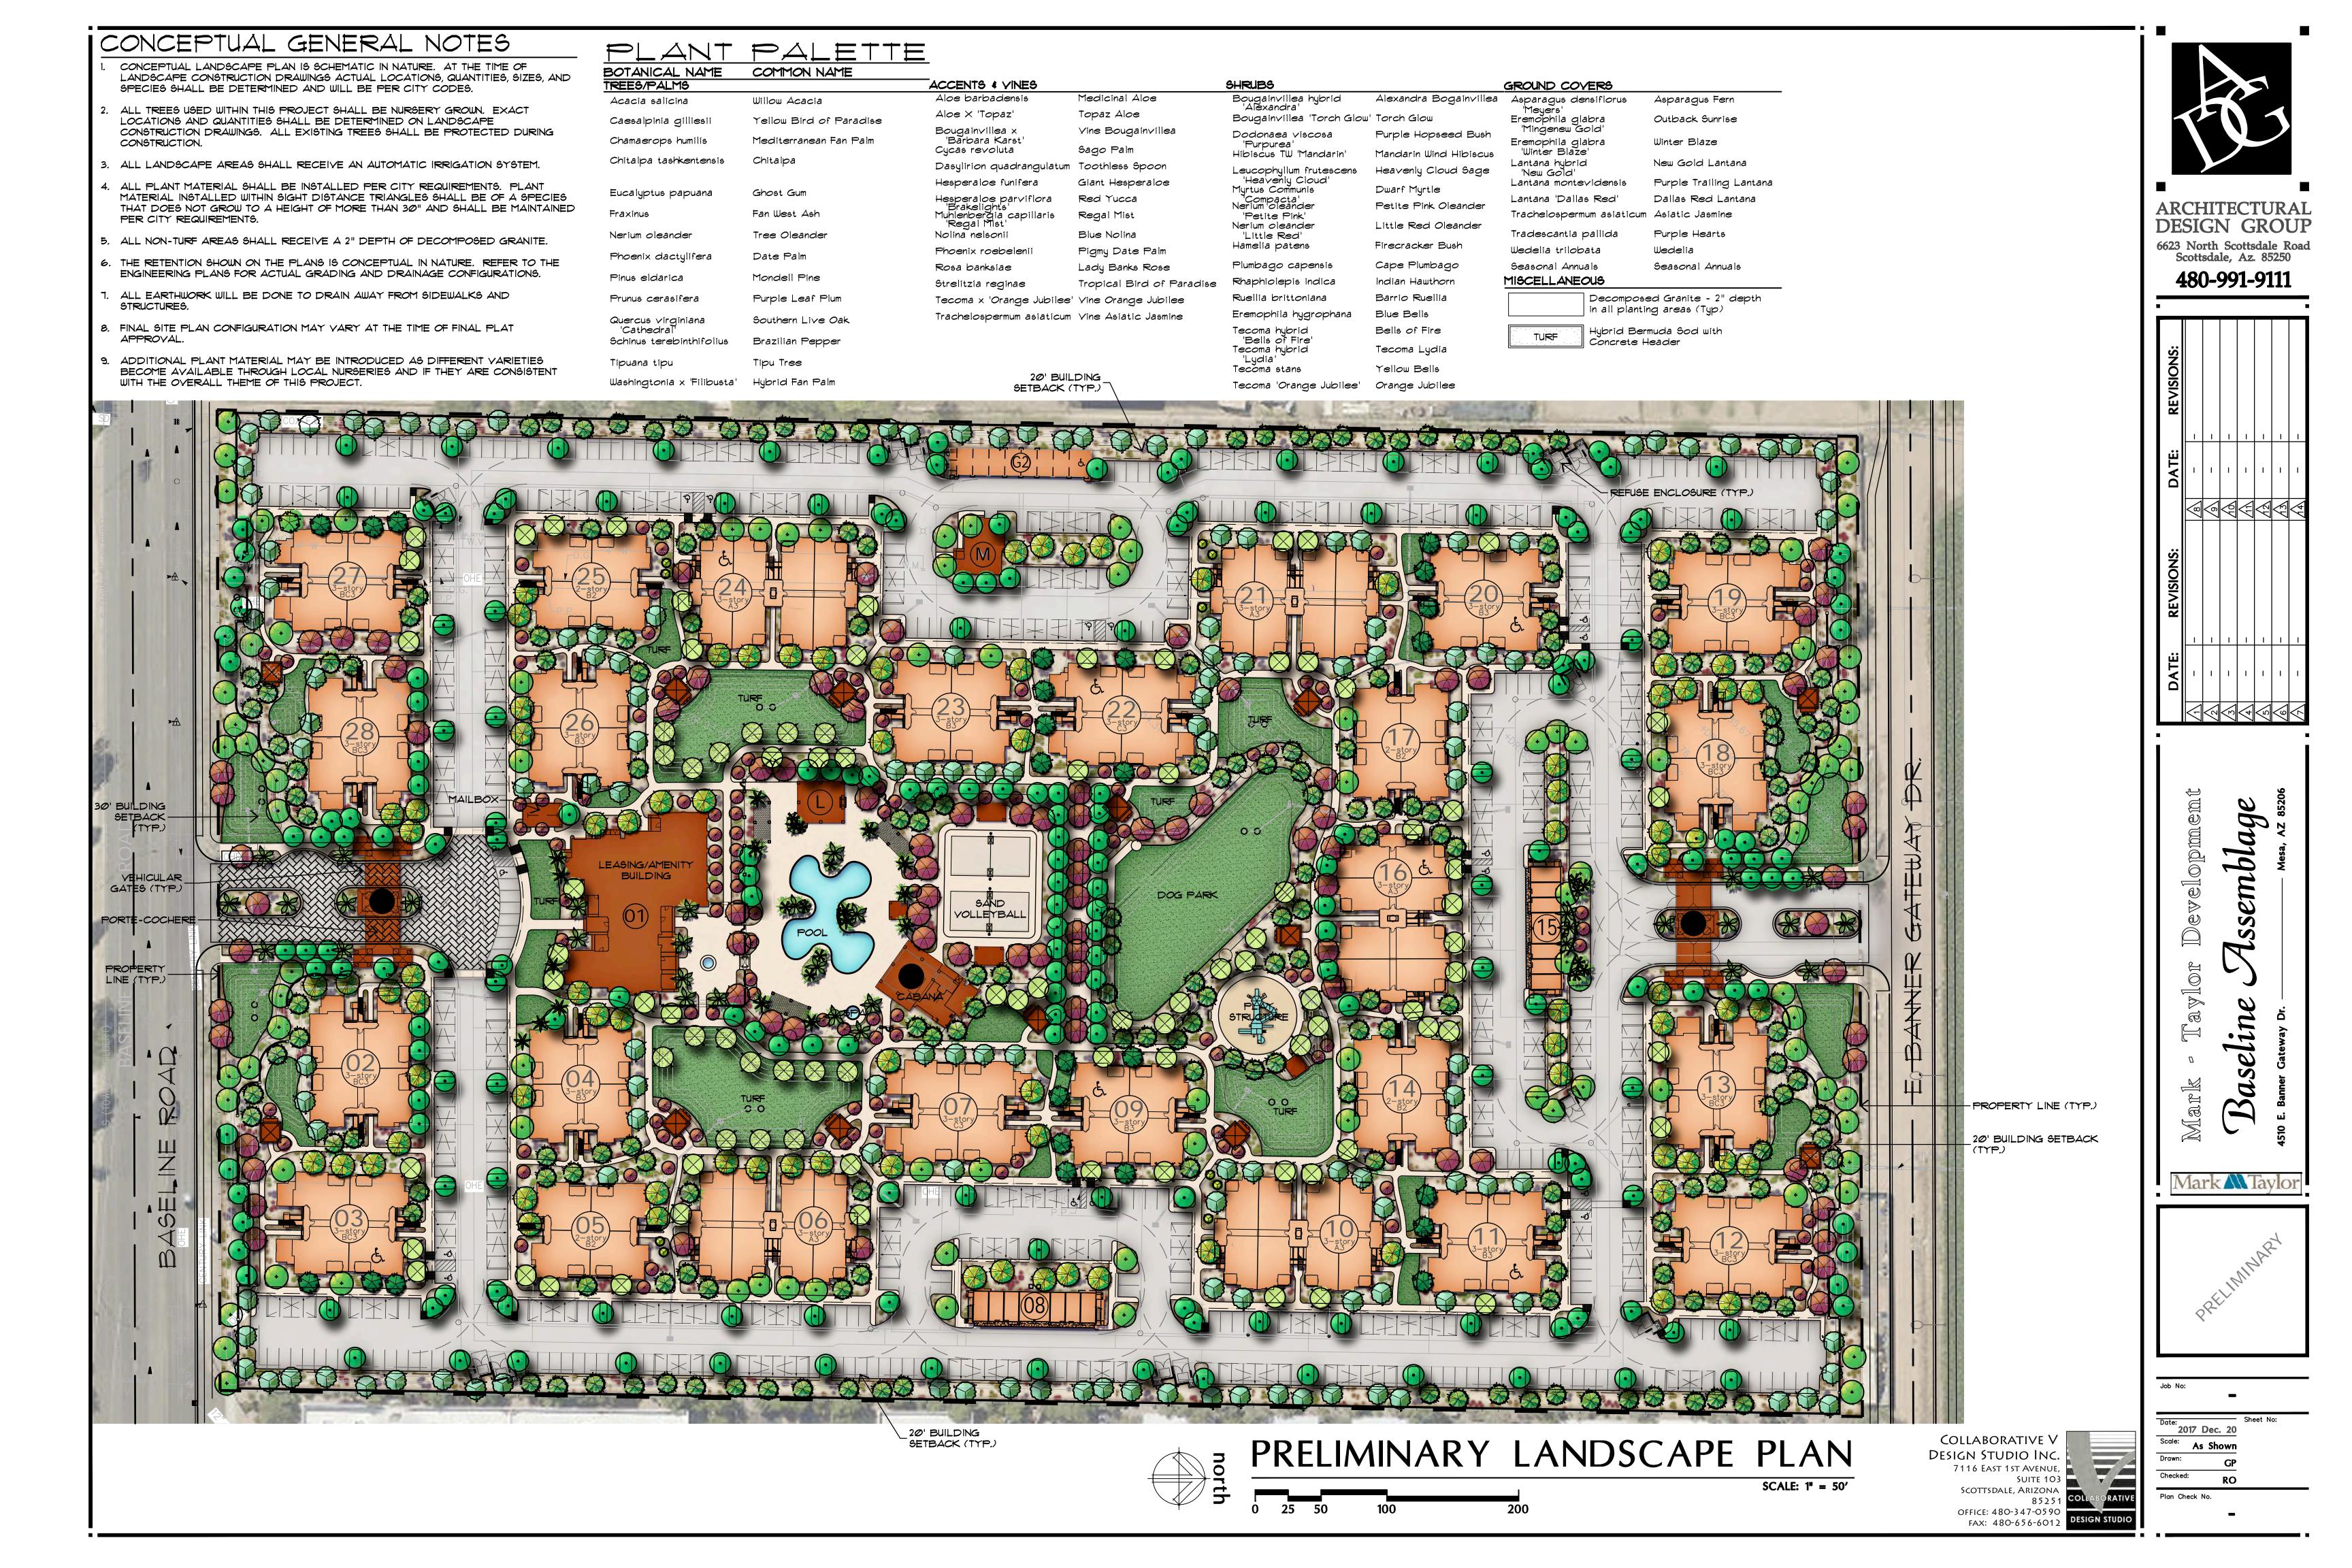



### NARRATIVE

Baseline Gateway Apartment Community on Baseline (between Iverness Ave and Pierpont Dr.)


The proposed apartment community on Baseline Rd. west of Pierpont Dr. in Mesa, AZ will consist of 348 apartment homes on approximately 21.6 acres. There will be 1, 2 & 3-bedroom unit types with the following mix: 1-bedroom 35%, 2-bedroom 51%, 3-bedroom 14%.

The majority of apartment buildings are of 3-story configurations with a few 2-story buildings. We favor smaller building footprints (primarily 4-plex) to keep the massing of the buildings at a comfortable scale that is pedestrian-friendly with more landscaped views and convenient circulation throughout the site. All buildings will be of wood frame construction (type V-A or V-B) and provided with automatic fire sprinklers as required. A great many of the units will face a grand and central open space which will contain the resort-style pool and activity center, the tot-lot playground area, dog-park, and quieter green spaces for passive enjoyment. Many units also face the generously landscaped open spaces along the street frontages providing presence, activity, and natural surveillance for those streets. The community will be accessed from Baseline Rd on the south, and Banner Gateway Dr. on the north – each with significant setbacks, landscaping, grand porte-cochere, and multiple pedestrian gates.


Upon entry, our residents and their guests will be greeted by either grand porte-cochere which declares their arrival at this gated community of refined apartment homes and amenities. The architecture will be an intentional and carefully measured combination of Spanish Colonial features and more contemporary elements to reflect the diversity of the region and compliment the surrounding neighborhood. Some of the features which contribute to the sophistication of this style include rich earth-toned "S" roof tile; specific and limited locations of corbelled roof overhangs and cantilevered portions of buildings to accentuate their distinction amongst the combinations of high and low, hipped and gabled roof elements; round-top windows; wrought iron railing, and details. The three-coat stucco system, characteristic of all Mark-Taylor projects, will be used throughout the project for its superior integrity and durability. The finish materials and paint colors will be a coordinated combination of earth-tones and complimentary accents to coalesce the architectural styles. The windows, both large and small, are consistent with the necessary privacy, potential view and natural lighting benefits of the spaces they serve. The vast majority of mechanical units (with one exception at the maintenance bldg) are hidden from eye-sight and ear-shot in mechanical wells on the roof to improve the serenity and enjoyment of the grounds throughout the community. The auxiliary buildings such as the detached garages, maintenance building, pool cabanas and ramadas will exhibit the same aesthetic style and attention to detail as the main buildings. The quality of the design, materials and construction will be consistent with the excellence for which Mark-Taylor has become known as a premier multi-family home builder in the valley.

The amenity building (clubhouse) will be approximately 10,000 s.f. and house the leasing office, residents' business center, state of the art fitness center, and social/TV lounge for casual enjoyment or special events. A large lagoon pool and spa will provide resort-like relaxation with surrounding ramadas, pool-side cabana, and outdoor lounge as the hub for gathering and entertainment. There will also be a sand volleyball court or two for active play. At the opposite end of the grand open-space is a dedicated dog park for the animal lovers, and a separate open area will provide a park-like setting with children play structures and nearby ramadas to accommodate family recreation. Convenient barbequing locations will be located throughout the project.


The community is favorably situated near shopping, schools, restaurants, and has convenient freeway access. This project will provide much needed housing options in the area to accommodate the surrounding employment opportunities.

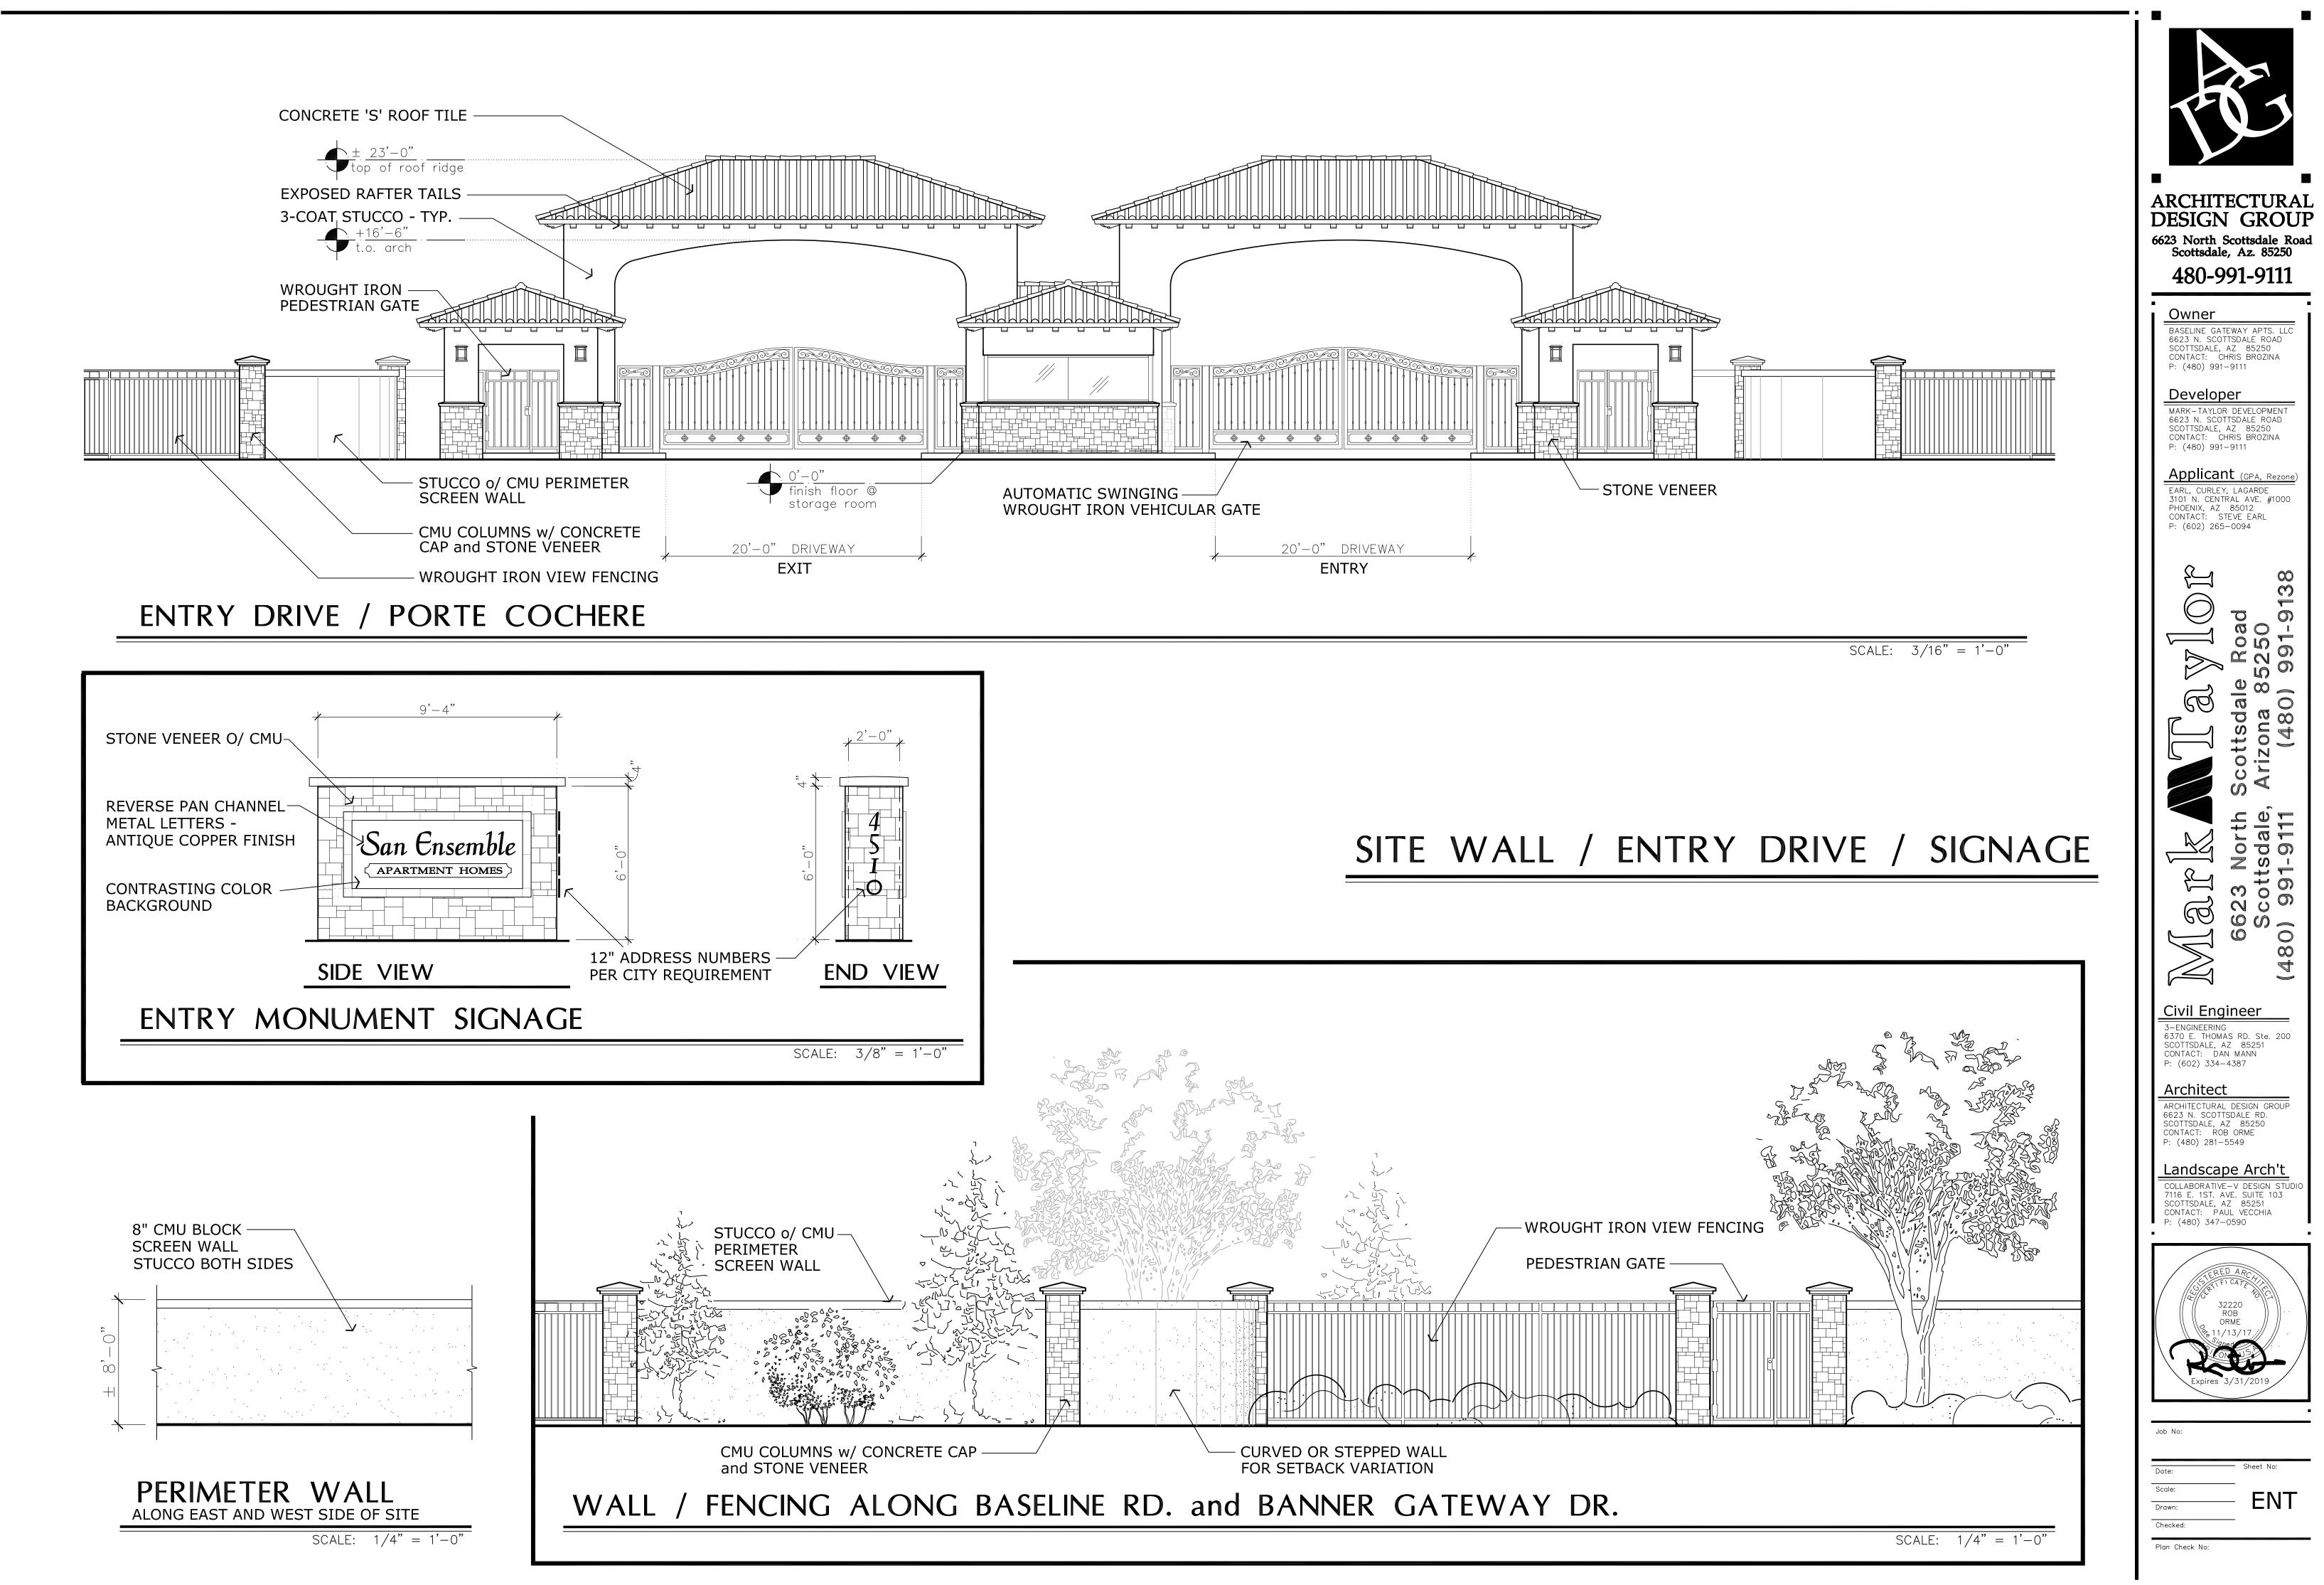


<sup>:\9999 -</sup> Mesa-Baseline-ASSEMBLAGE\EXHIBITS\DRB\CAD\009-Theme Wall-Gate-Fence Exhibit\_Assemblage-DRB.dwg, 10/31/2017 4:51:39 PM

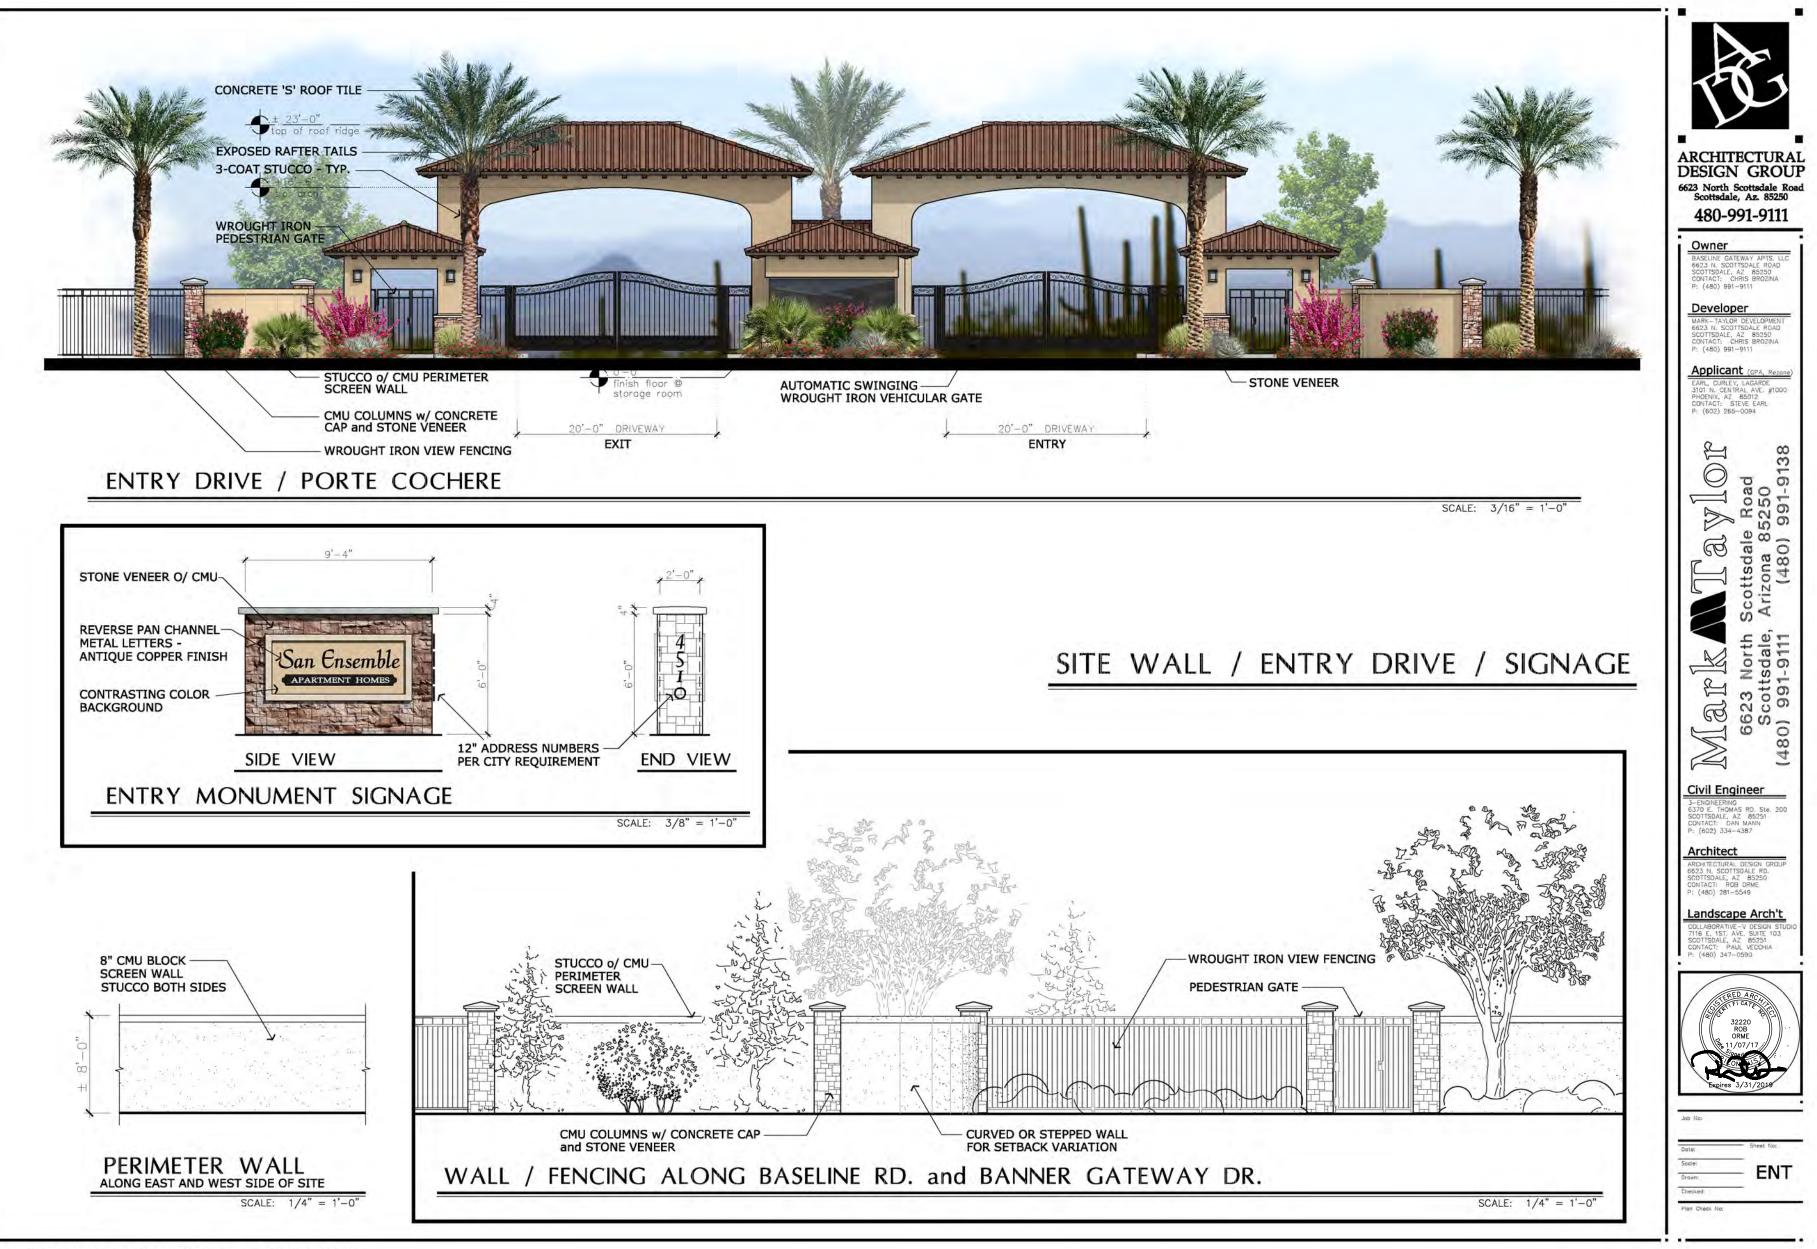

- Mesa-Baseline-ASSEMBLAGE\EXHIBITS\DRB\CAD\009-Theme Wall-Gate-Fence Exhibit\_Assemblage-DRB.dwg, 10/31/2017 4:51:39 P

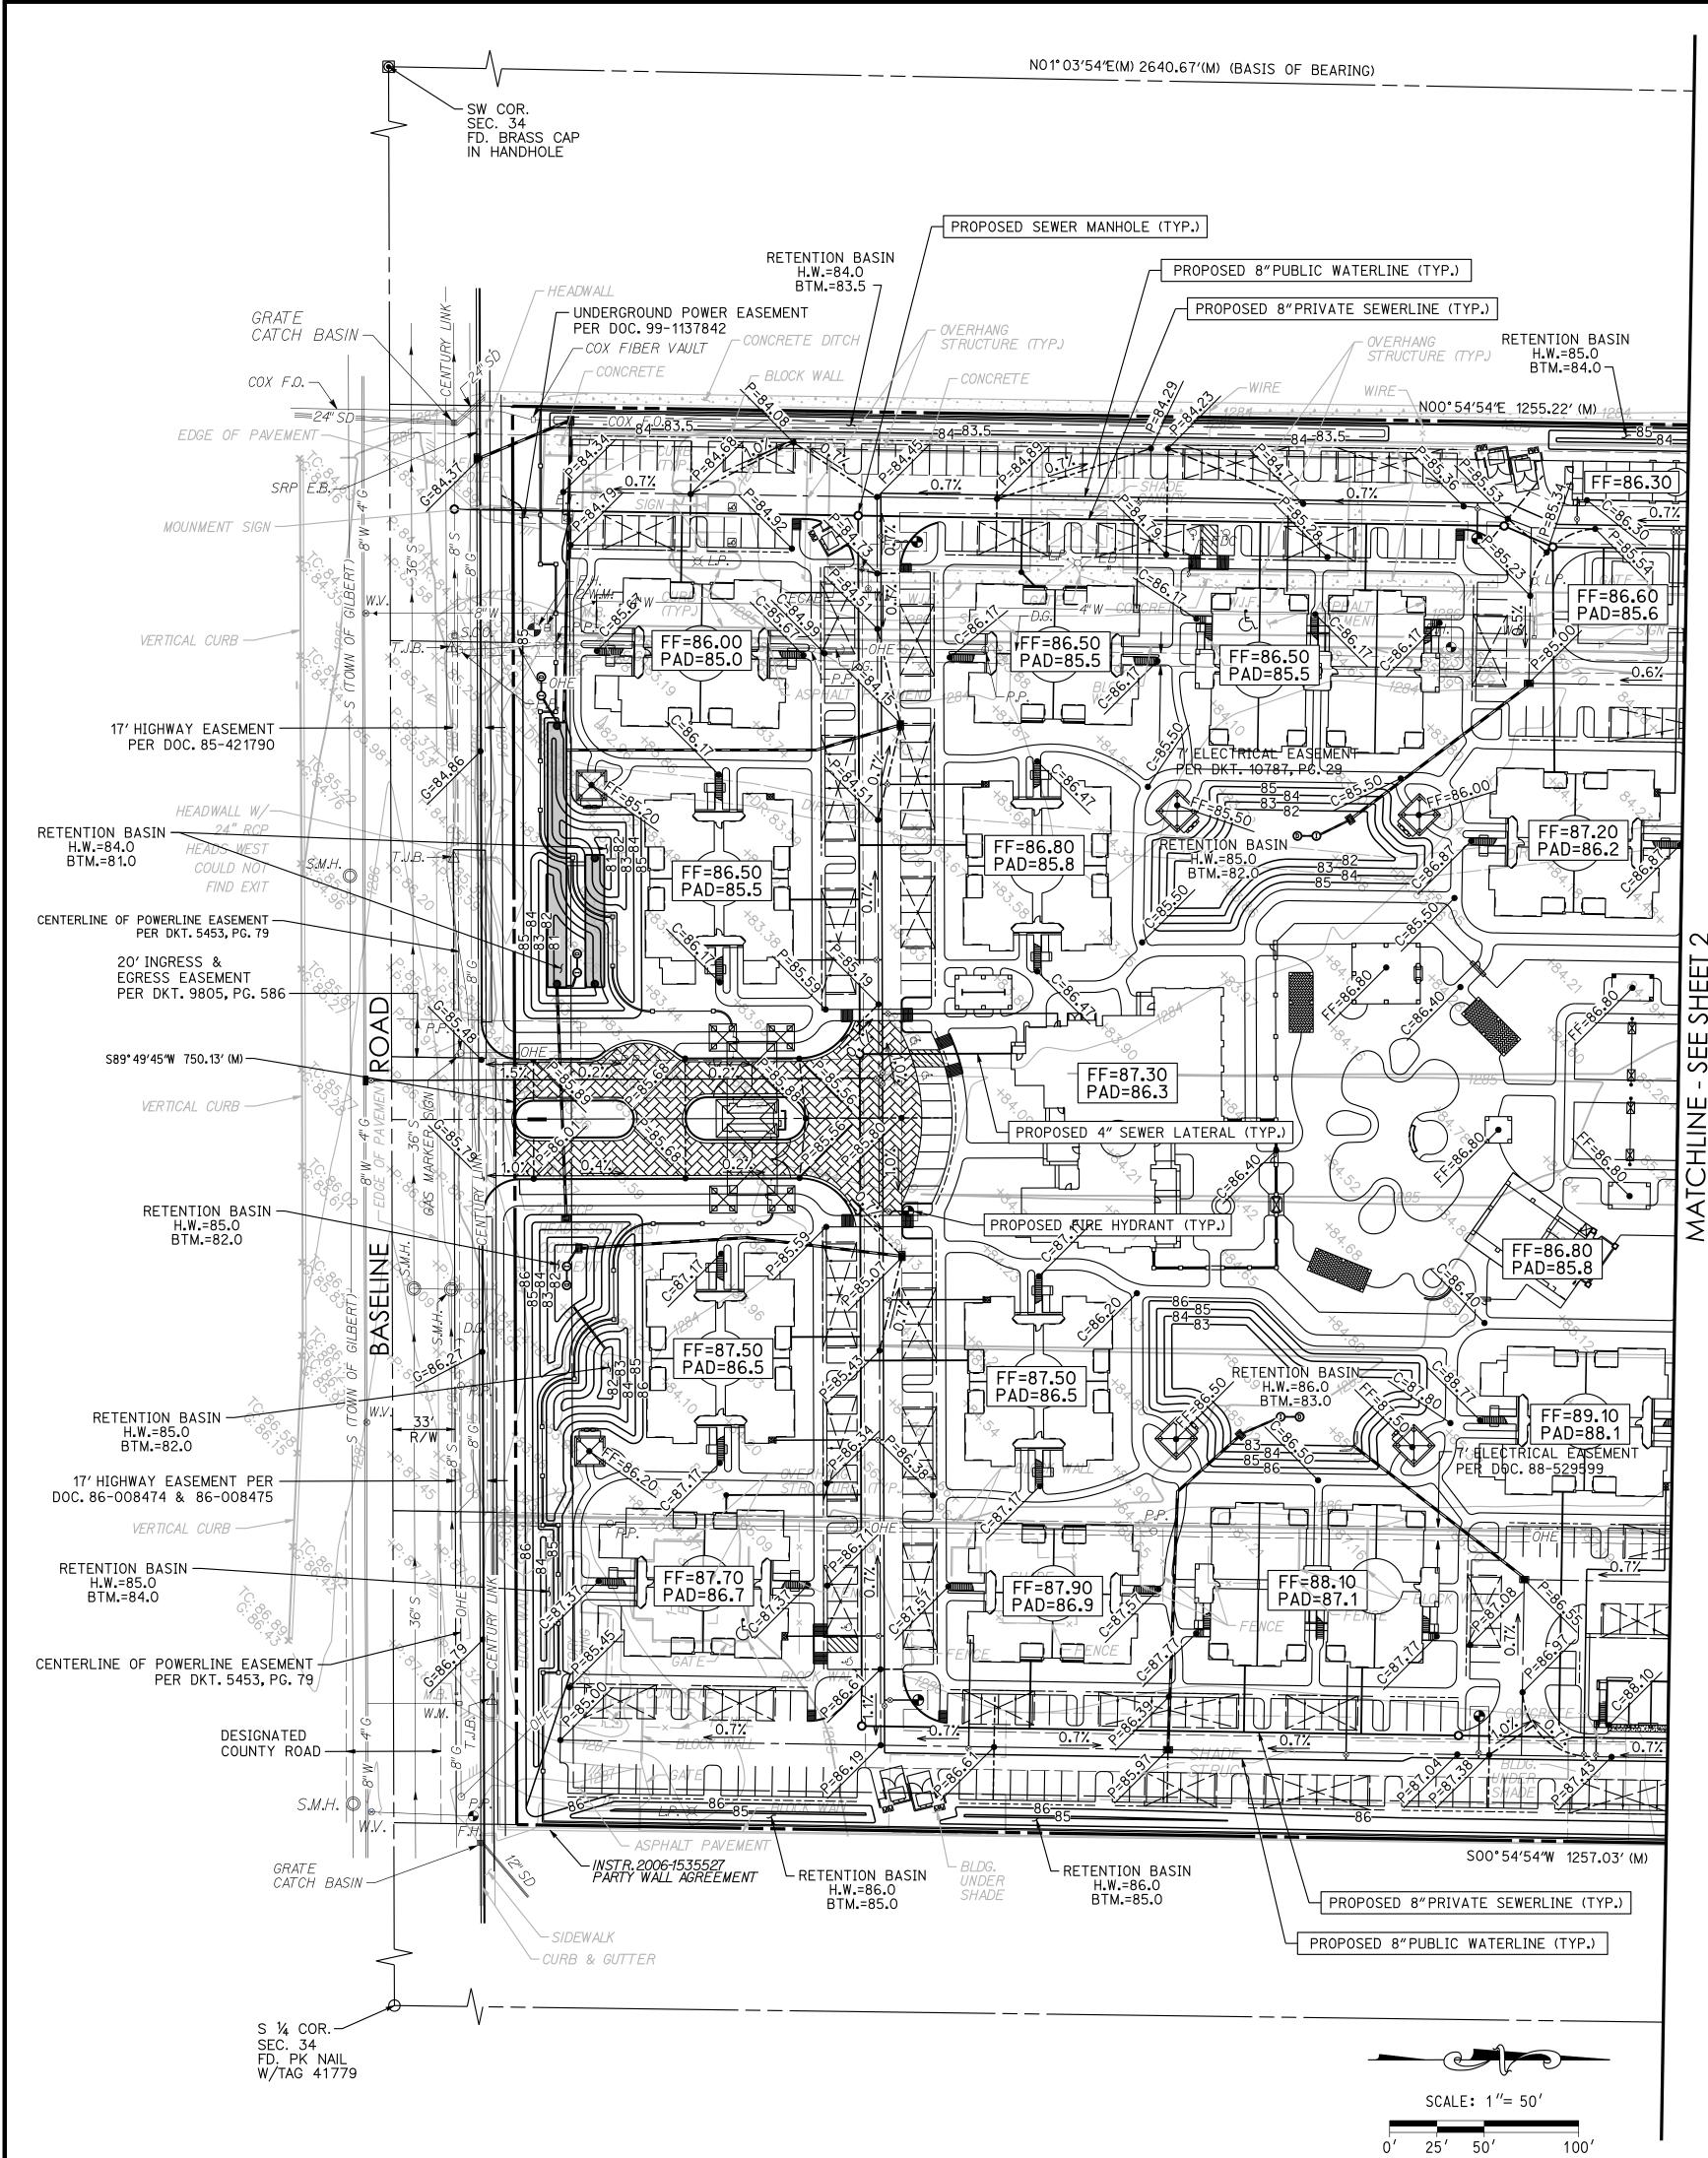


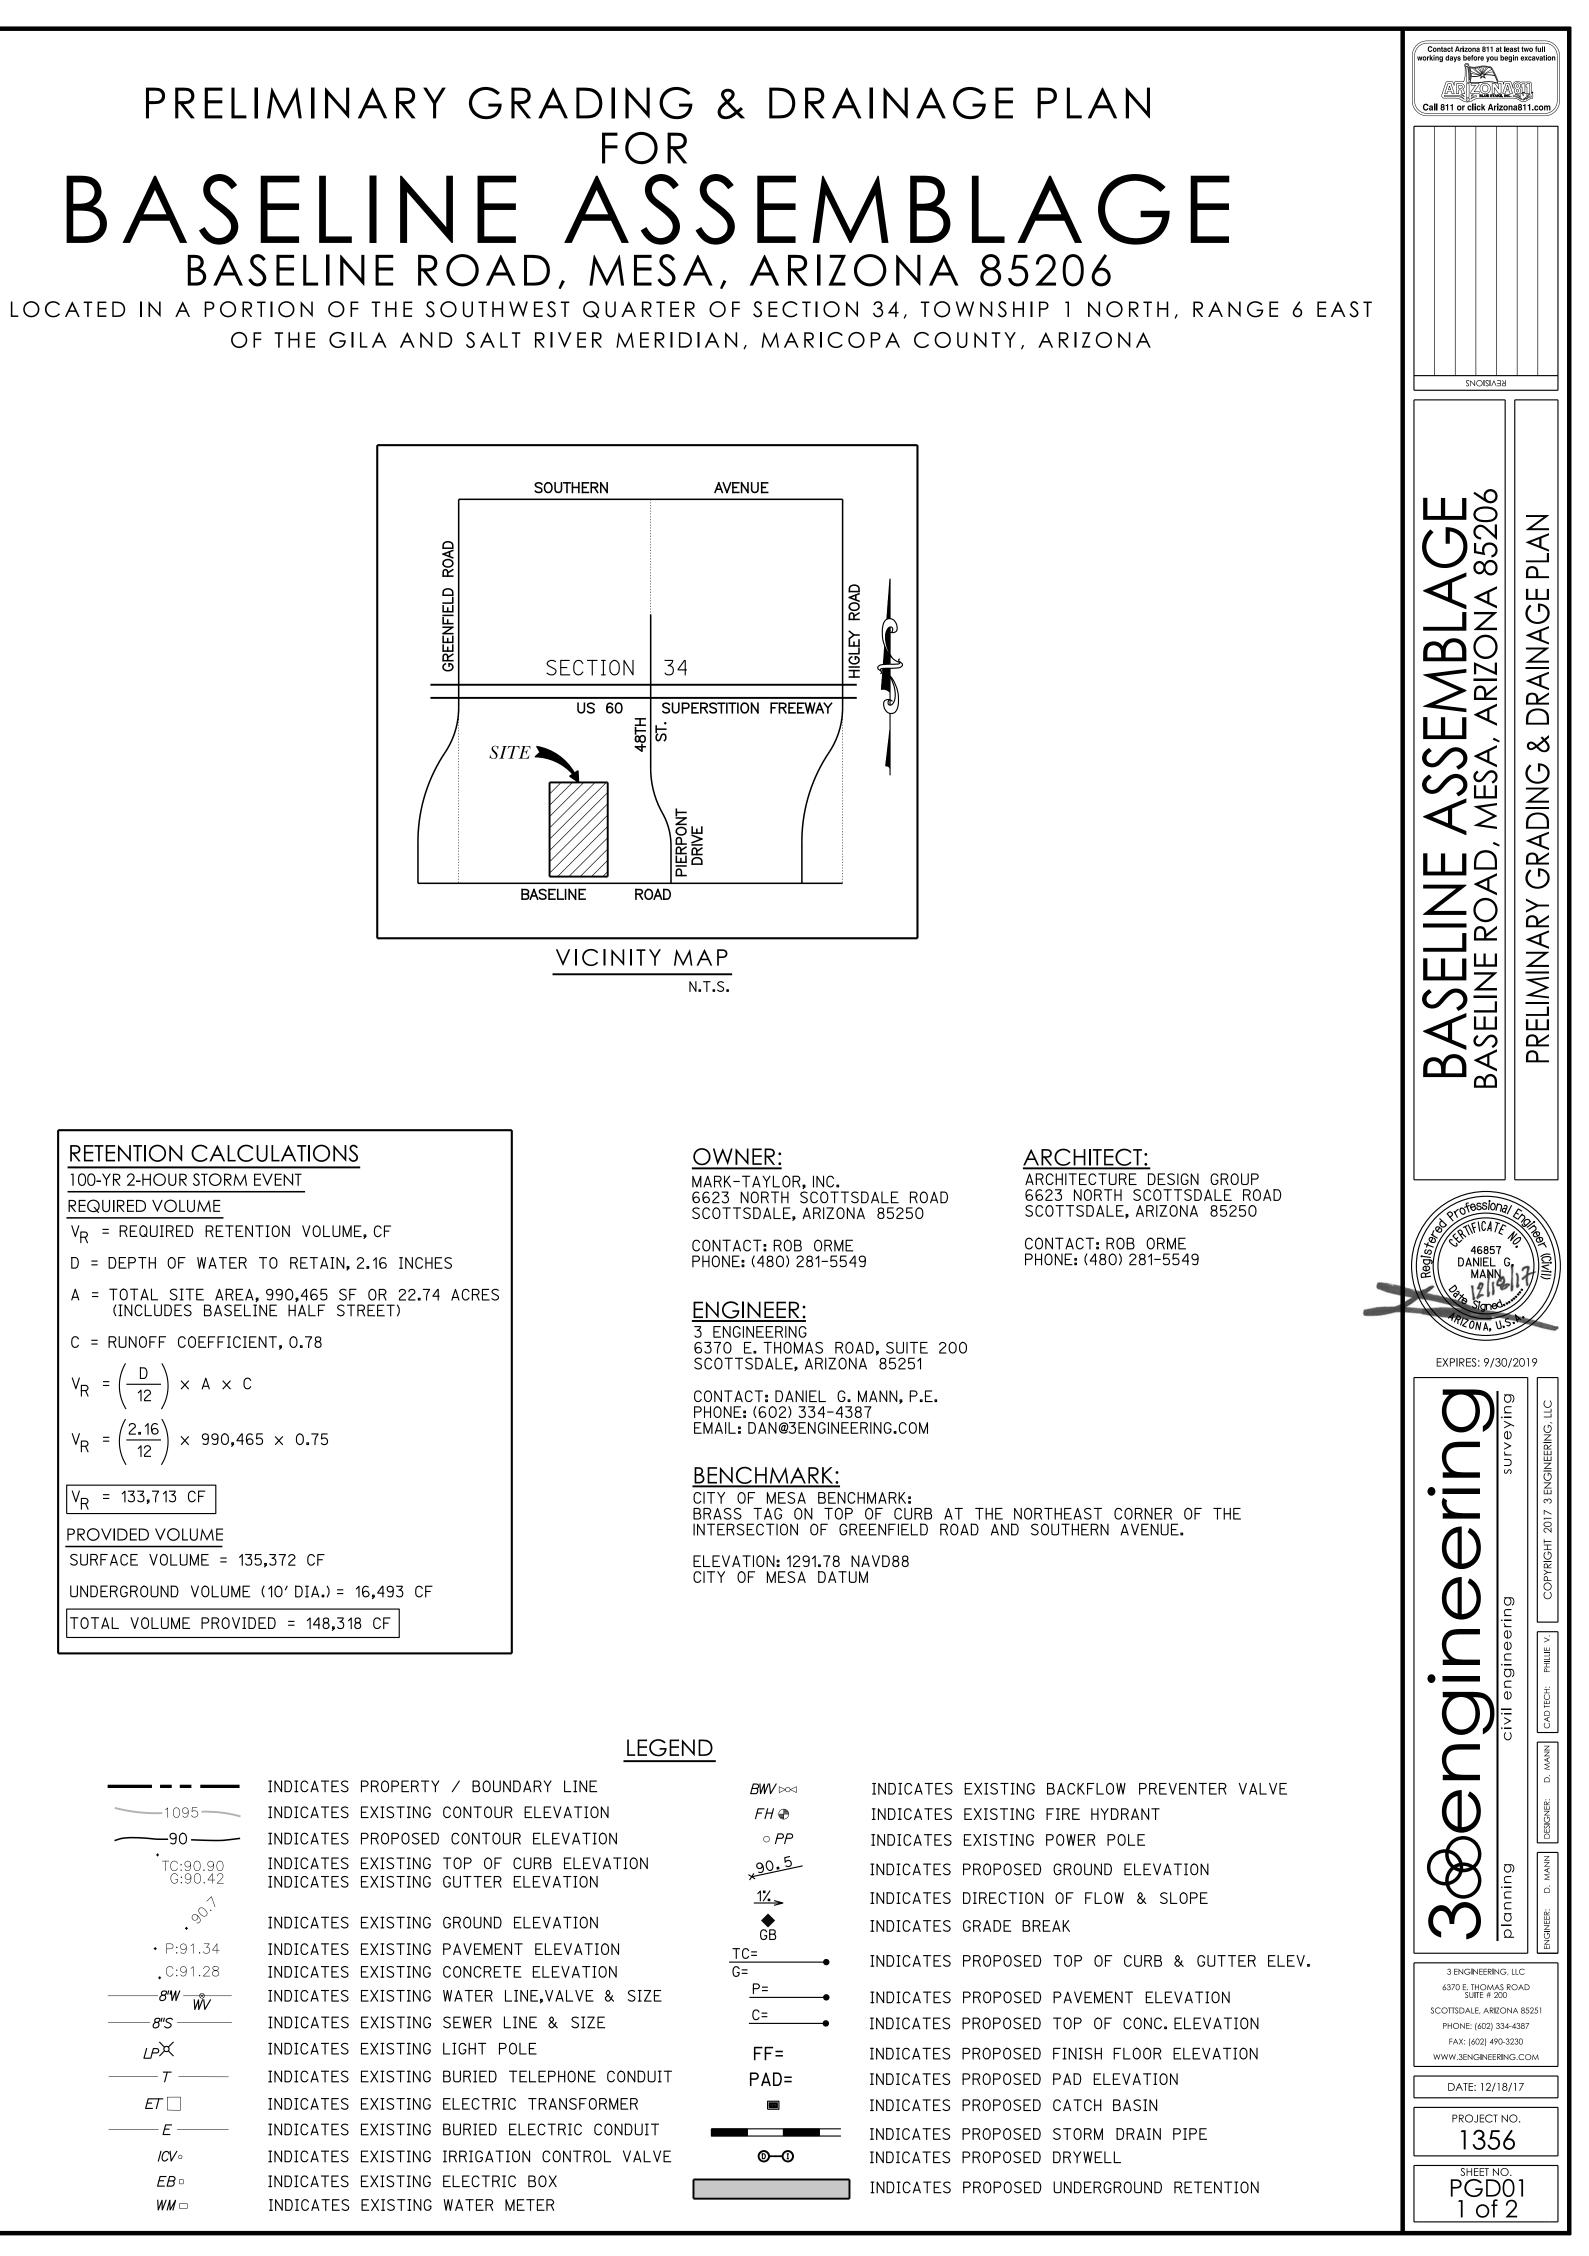

RETENTION CALCULATIONS				
100-YR 2-HOUR STORM EVENT				
REQUIRED VOLUME				
V <sub>R</sub> = REQUIRED RETENTION VOLUME, CF				
D = DEPTH OF WATER TO RETAIN, 2.16 INCHES				
A = TOTAL SITE AREA, 990,465 SF OR 22.74 ACRES (INCLUDES BASELINE HALF STREET)				
C = RUNOFF COEFFICIENT, 0.78				
$V_{R} = \left(\frac{D}{12}\right) \times A \times C$				
$V_{R} = \left(\frac{2.16}{12}\right) \times 990,465 \times 0.75$				
V <sub>R</sub> = 133,713 CF				
PROVIDED VOLUME				
SURFACE VOLUME = 135,372 CF				
UNDERGROUND VOLUME (10' DIA.) = 16,493 CF				
TOTAL VOLUME PROVIDED = 148,318 CF				

	INDICA
1095	INDICA
90	INDICA
• TC:90.90 G:90.42	INDICA INDICA
• 90 <sup>.1</sup>	INDICA
• P:91.34	INDICA
.C:91.28	INDICA
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INDICATES	PROPOSED	CONTOUR ELEV
	EXISTING	TOP OF CURB E
INDICATES	EXISTING	GUTTER ELEVAT
INDICATES	EXISTING	GROUND ELEVAT
INDICATES	EXISTING	PAVEMENT ELEV
INDICATES	EXISTING	CONCRETE ELEV
INDICATES	EXISTING	WATER LINE,VAL
INDICATES	EXISTING	SEWER LINE &
INDICATES	EXISTING	LIGHT POLE
INDICATES	EXISTING	BURIED TELEPHO
INDICATES	EXISTING	ELECTRIC TRANS
INDICATES	EXISTING	BURIED ELECTRI
INDICATES	EXISTING	IRRIGATION CON
INDICATES	EXISTING	ELECTRIC BOX
INDICATES	EXISTING	WATER METER

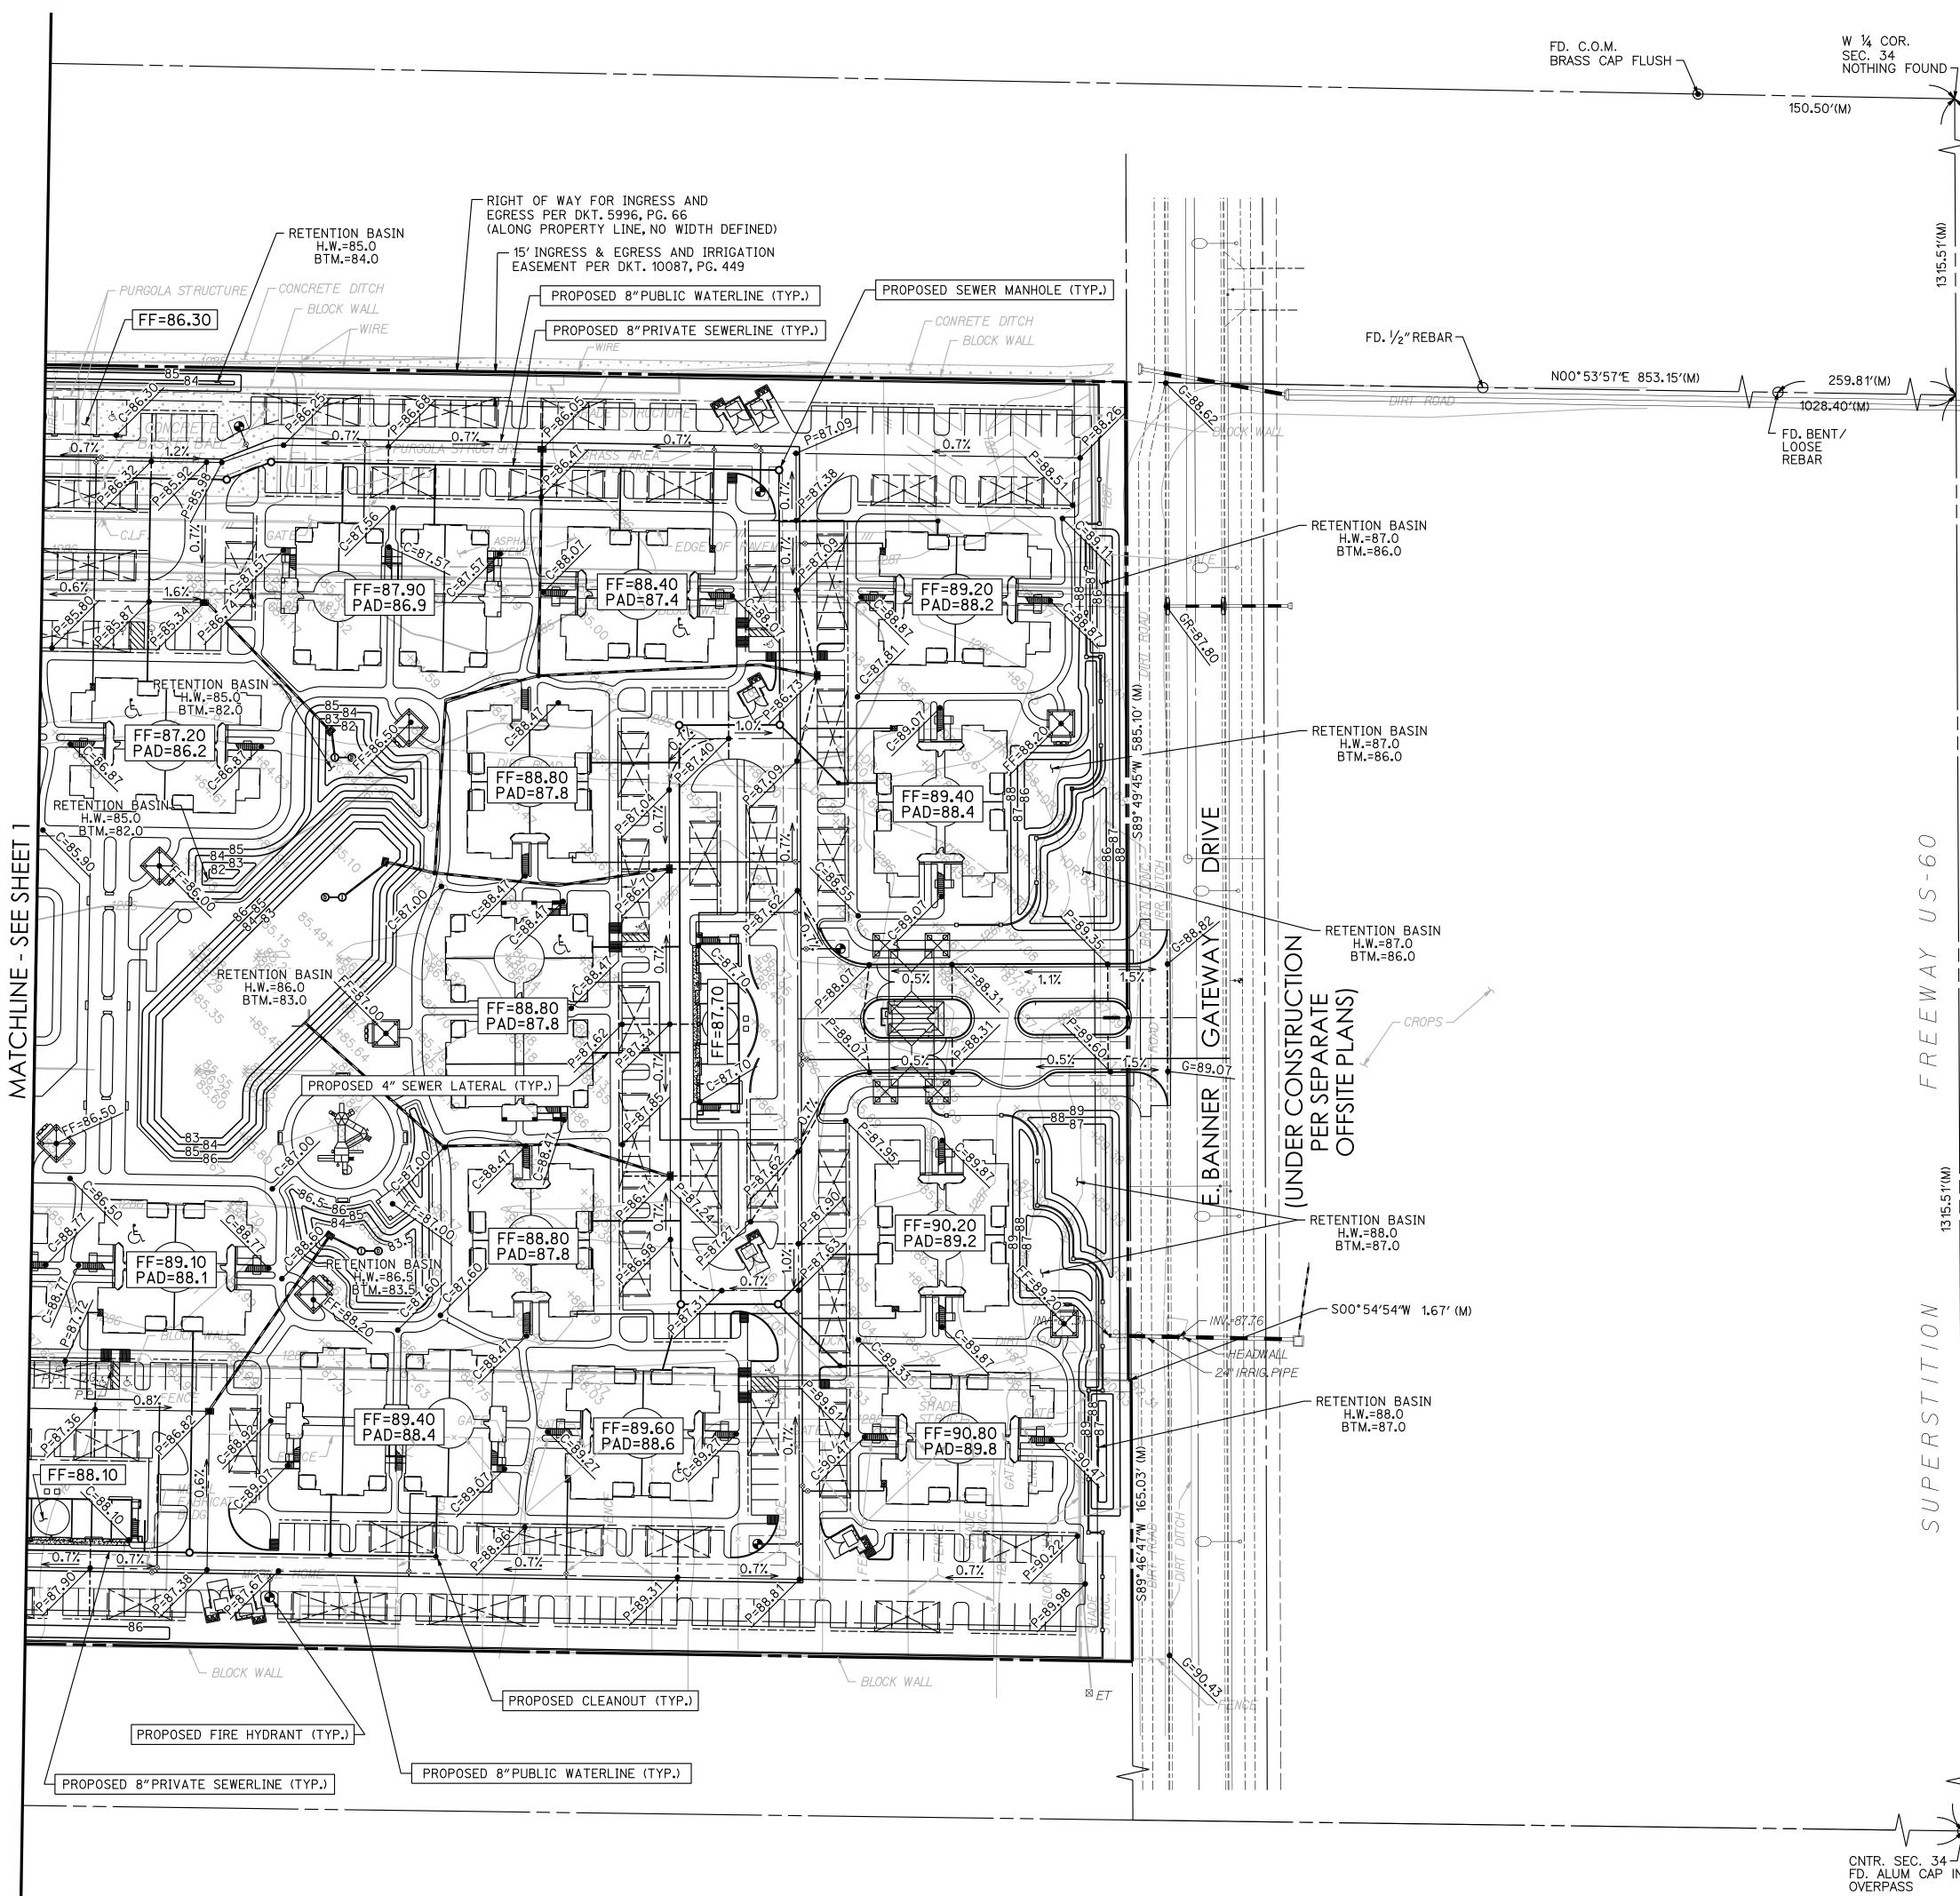

	BASELINE RASSEMBLAGE   BASELINE ROAD, MESA, ARIZONA 85206   BASELINE ROAD, MESA, ARIZONA 85206   PREIMINARY GRADING & DRAINAGE PLAN
SCALE: $1''=50'$	<text></text>

OWNER: MARK-TAYLOR, INC. 6623 NORTH SCOTTSDALE ROAD SCOTTSDALE, ARIZONA 85250

CONTACT: ROB ORME PHONE: (480) 281-5549

## BENCHMARK:

CITY OF MESA BENCHMARK: BRASS TAG ON TOP OF CURB AT THE NORTHEAST CORNER OF THE INTERSECTION OF GREENFIELD ROAD AND SOUTHERN AVENUE. ELEVATION: 1291.78 NAVD88 CITY OF MESA DATUM

ARCHITECT:

CONTACT: ROB ORME

PHONE: (480) 281-5549

ARCHITECTURE DESIGN GROUP

SCOTTSDALE, ARIZONA 85250

6623 NORTH SCOTTSDALE ROAD


## BASIS OF BEARING:

THE BASIS OF BEARING IS THE WEST LINE OF THE SOUTHWEST QUARTER OF SECTION 34, TOWNSHIP 1 NORTH, RANGE 6 EAST OF THE GILA AND SALT RIVER MERIDIAN, USING A BEARING OF NORTH 01 DEGREES 03 MINUTES 54 SECONDS EAST, AS SHOWN ON THE RECORDED SURVEY RECORDED IN BOOK 543 OF MAPS, PAGE 35, RECORDS OF MARICOPA COUNTY, ARIZONA. ENGINEER: 3 ENGINEERING 6370 E. THOMAS ROAD, SUITE 200 SCOTTSDALE, ARIZONA 85251

CONTACT: DANIEL G. MANN, P.E. PHONE: (602) 334-4387 EMAIL: DAN@3ENGINEERING.COM

### FLOOD ZONE:

THIS SITE IS LOCATED IN ZONE "X" (SHADED) "F.E.M.A." FLOOD MAP NO. 04013C2290L, DATE ZONE "X" (SHADED) IS DEFINED AS AREAS OF FLOOD; AREAS OF 1% ANNUAL CHANCE FLOOD DEPTHS OF LESS THAN 1 FOOT OR WITH DRA THAN 1 SQUARE MILE; AND AREAS PROTECTED % ANNUAL CHANCE FLOOD. ZONE "AH" IS DEFIN FLOOD DEPTHS OF ONE (1) TO THREE (3) FEE OF PONDING); BASE FLOOD ELEVATIONS HAVE

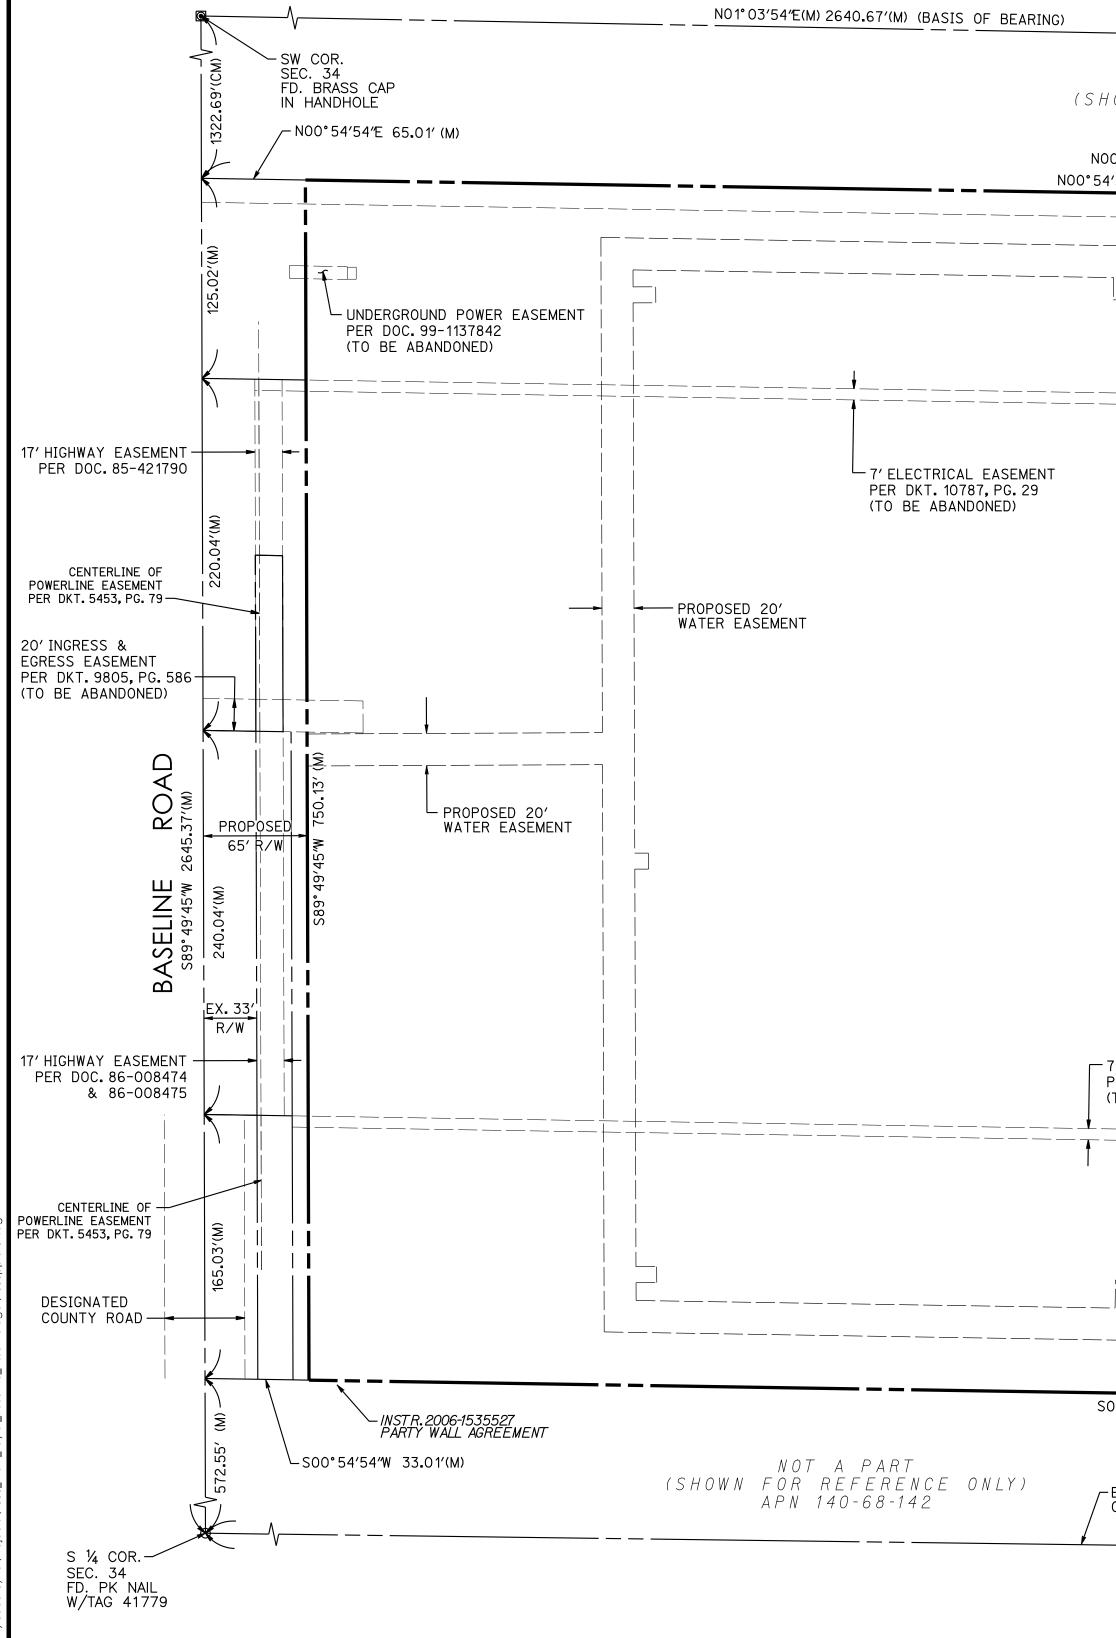

BA LOCATED IN A PO	SELINE RC	DAD, MESA	A, ARIZO	ABLAC DNA 85206 34, TOWNSHIP 1 NO PA COUNTY, ARIZON
AND ZONE "AH" PER ED: OCTOBER 16, 2013. O.2% ANNUAL CHANCE D WITH AVERAGE AINAGE AREAS LESS D BY LEVEES FROM 1 INED AS AREAS WITH ET (USUALLY ARES E BEEN DETERMINED.				
NOT A PART OWN FOR REFERENCE ONL D°54′54′E 1320.24′(CM) ′54′E 1255.22′ (M)	Y) WEST LINE OF THE E <sup>1</sup> / <sub>2</sub> OF THE SW <sup>1</sup> / <sub>4</sub>	RIGHT OF WAY FOR ING EGRESS PER DKT. 5996, (ALONG PROPERTY LINE 15' INGRESS & EGF EASEMENT PER DK	, PG. 66 , NO WIDTH DEFINED) RESS AND IRRIGATION	
PROPOSED 20' WATER EASEMENT				30' RIGHT-OF-WAY (TO BE ABANDONED)
LOT 1 21.62 ACRE	S	PROPOSE WATER E		   PROPOSED 20' WATER EASEMENT
' ELECTRICAL EASEMENT 'ER DOC. 88-529599 TO BE ABANDONED) 				
PROPOSED 20' WATER EASEME	NT 			
EAST LINE OF THE SW 1/4		(SHOWN FOR RE	PART FERENCE ONL 0-68-137	γ)

